

ជ	GENERAL NOTES		DRAWING INDEX	INDEX
			NUMBER TITLE	HE
	The Contractor is to comply with the latest and most current additions of state and local building codes and regulations as		G1.0	GENERAL
	weil as Local, State and Federal regulations regarding health		A1.0	SITE PLAN AND QUANTITIES
	and safety in the workplace.		A1.1	TRESTLE WEST PLAN
,			A1.2	TRESTLE EAST PLAN
2	All existing conditions shall be verified by the Contractor prior		A1.3	NORTH LANDING PLAN

- the attention of the Architect in writing immediately. and the intent of the Contract Documents shall be brought to existing conditions and these drawings which affect the scope to fabrication and construction. Any discrepancies between All existing conditions shall be verified by the Contractor prior
- conditions damaged during construction are to be repaired Existing viaduct and adjacent spaces are to be protected during demolition and construction as required. Any existing Contractor's expense. and/or replaced to match the original existing condition at the
- weather protection for the existing structure and new construction during the full scope of construction activity on The Contractor is to provide all necessary temporary and
- See the WisDot Specifications and the Special Provisions Sections of the Specification Requirements of the project.
- Any errors or omissions are to be brought to the attention of the Architect.

Quantities can be found on drawings A1.0, S1.2 and S2.1

GENERAL INFORMATION

\$1.1 \$1.2

QUANTITIES AND GENERAL NOTES

GENERAL PLAN

MILWAUKEE, WI 53214 414.259.1500	STRUCTURAL ENGINEER GRAEF ANHALT SCHLOEMER AND ASSOCIATES INC. 125 S. 84TH ST. SUITE 401		414.225.7450	MILWAUKEE, WI 53202	225 E. ST. PAUL AVE. SUITE 302	LA DALLMAN ARCHITECTS INC.	ARCHITECT	
MILWAUKEE, WI 53202 414.286.2451	CITY OF MILWAUKEE PLANNING & DEVELOPMENT 841 N. BROADWAY RM 919		414.329.2827	MILWAUKEE, WI 53202	311 E. CHICAGO ST. SUITE 310	THE MATRIX GROUP ENGINEERING CONSULTANTS	ELECTRICAL	William Adv.
S3.1	S2.1 S2.2	S1.9	S1.8	S1.7	S1.6	S1.5	S1.4	S1.3
PLAZA BENCH	GENERAL PLAN AND ELEVATION CROSS SECTION AND DETAILS	WEST STAIRS	DECORATIVE RAILING DETAILS	DECK DETAILS	CONCRETE DECK DETAILS	DETAILS	FRAMING DETAILS	DEMOLITION PLAN

E1.5	E1.4	E1.3	E1.2	E1.1	E1.0	E0.0	A4.0	A3.9	A3.8	A3.7	A3.6	A3.5	A3.4	A3.3	A3.2	A3.1	A3.0	55	A2.3	A2.2	A2.1	A2.0	
ELECTRICAL DETAILS	TRESTLE GUARDRAIL LIGHTING PLAN	TRESTLE WEST - ELECTRICAL PLAN	TRESTLE EAST - ELECTRICAL PLAN	NORTH LANDING - ELECTRICAL PLAN	OVERALL SITE PLAN - ELECTRICAL	ELECTRICAL GENERAL NOTES AND SCHEDULES	LANDSCAPE PLAN	GUARDRAIL DIAGRAMS	NORTH LANDING DETAILS	WOOD DETAILS	WOOD DETAILS	CONCRETE DETAILS	CONCRETE SLAB DETAILS	HANDRAIL DETAILS	GUARDRAIL DETAILS	GUARDRAIL DETAILS	GUARDRAIL DETAILS		TRESTLE SECTIONS	TRESTLE SECTIONS	TRESTLE SECTIONS	TRESTLE SECTIONS	

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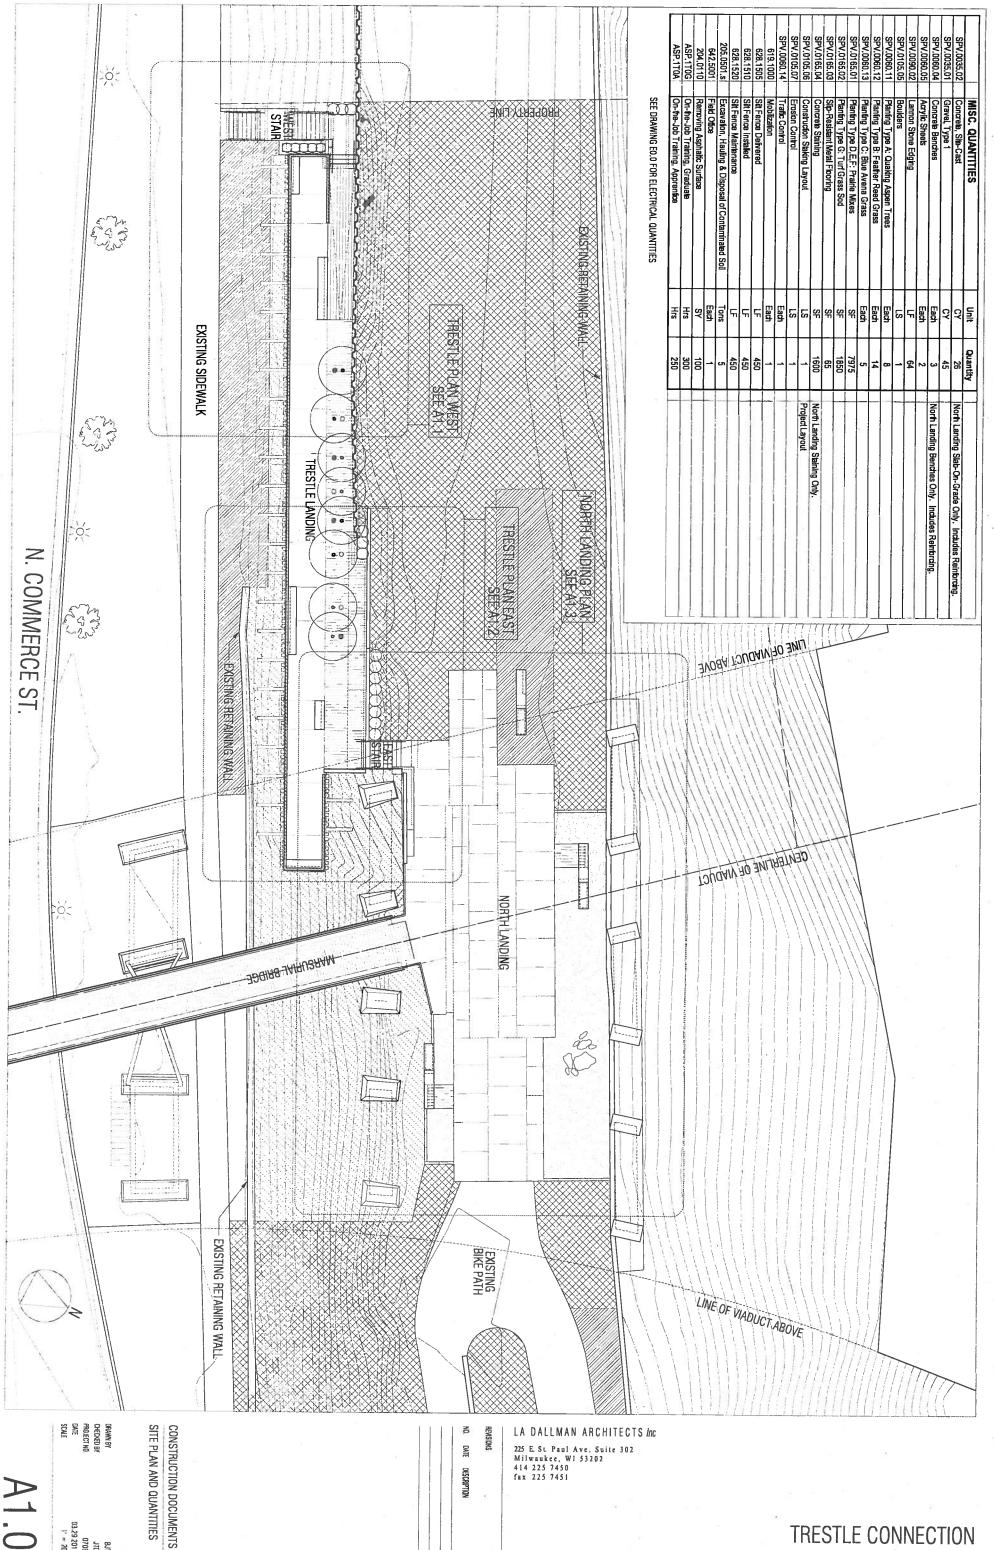
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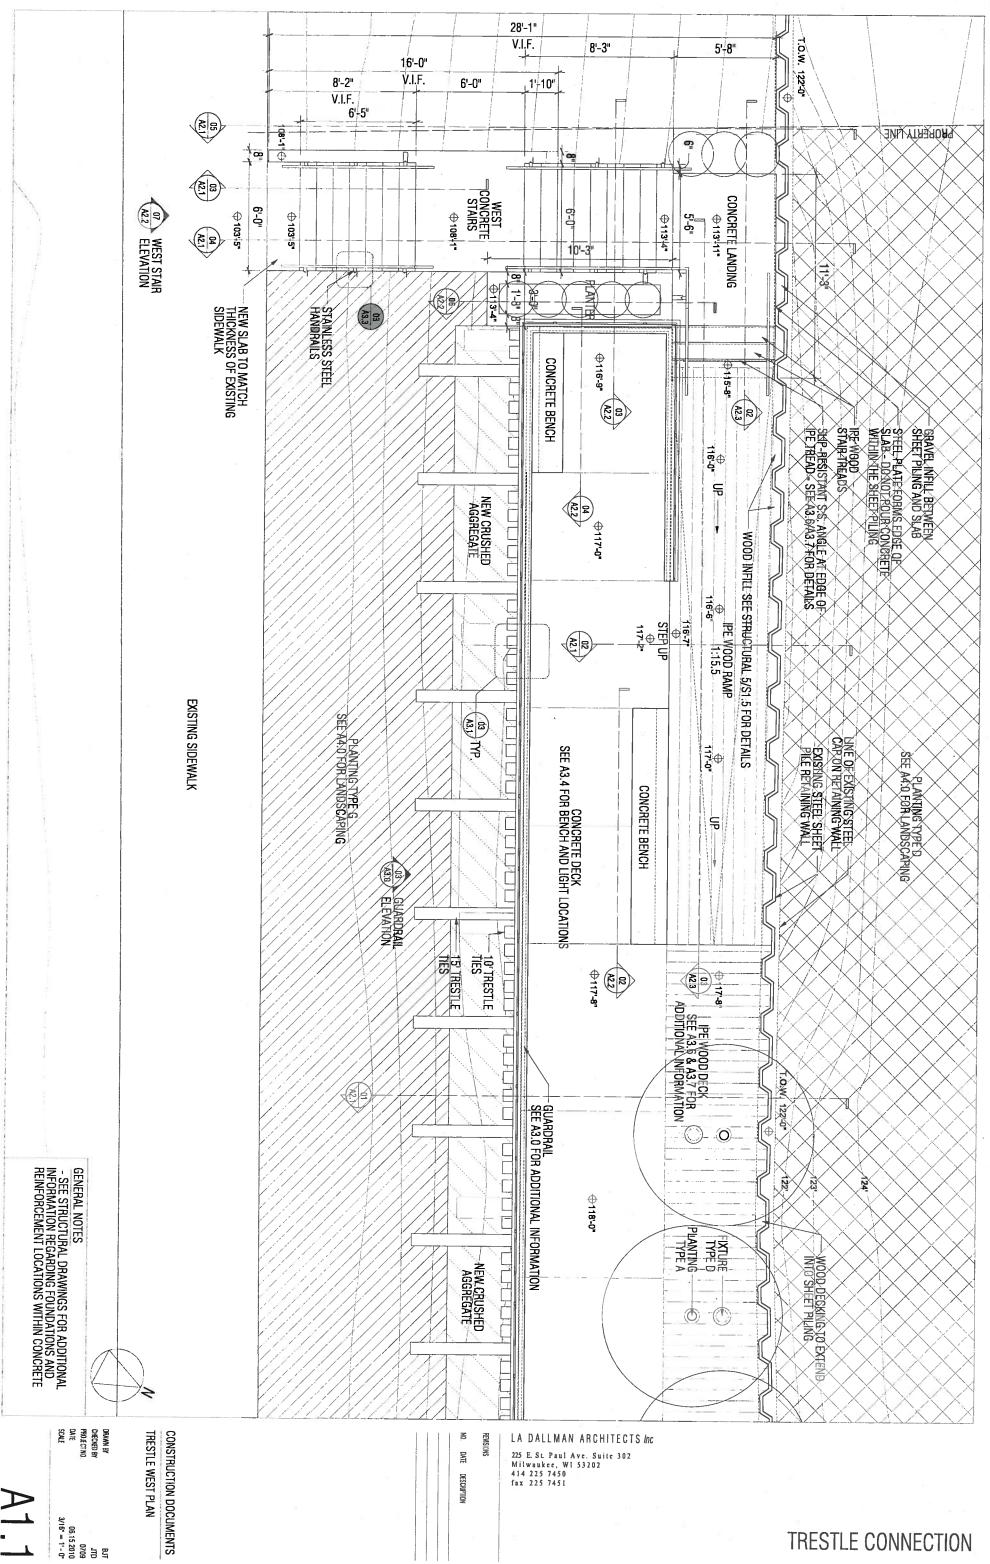
GENERAL INFORMATION CONSTRUCTION DOCUMENTS


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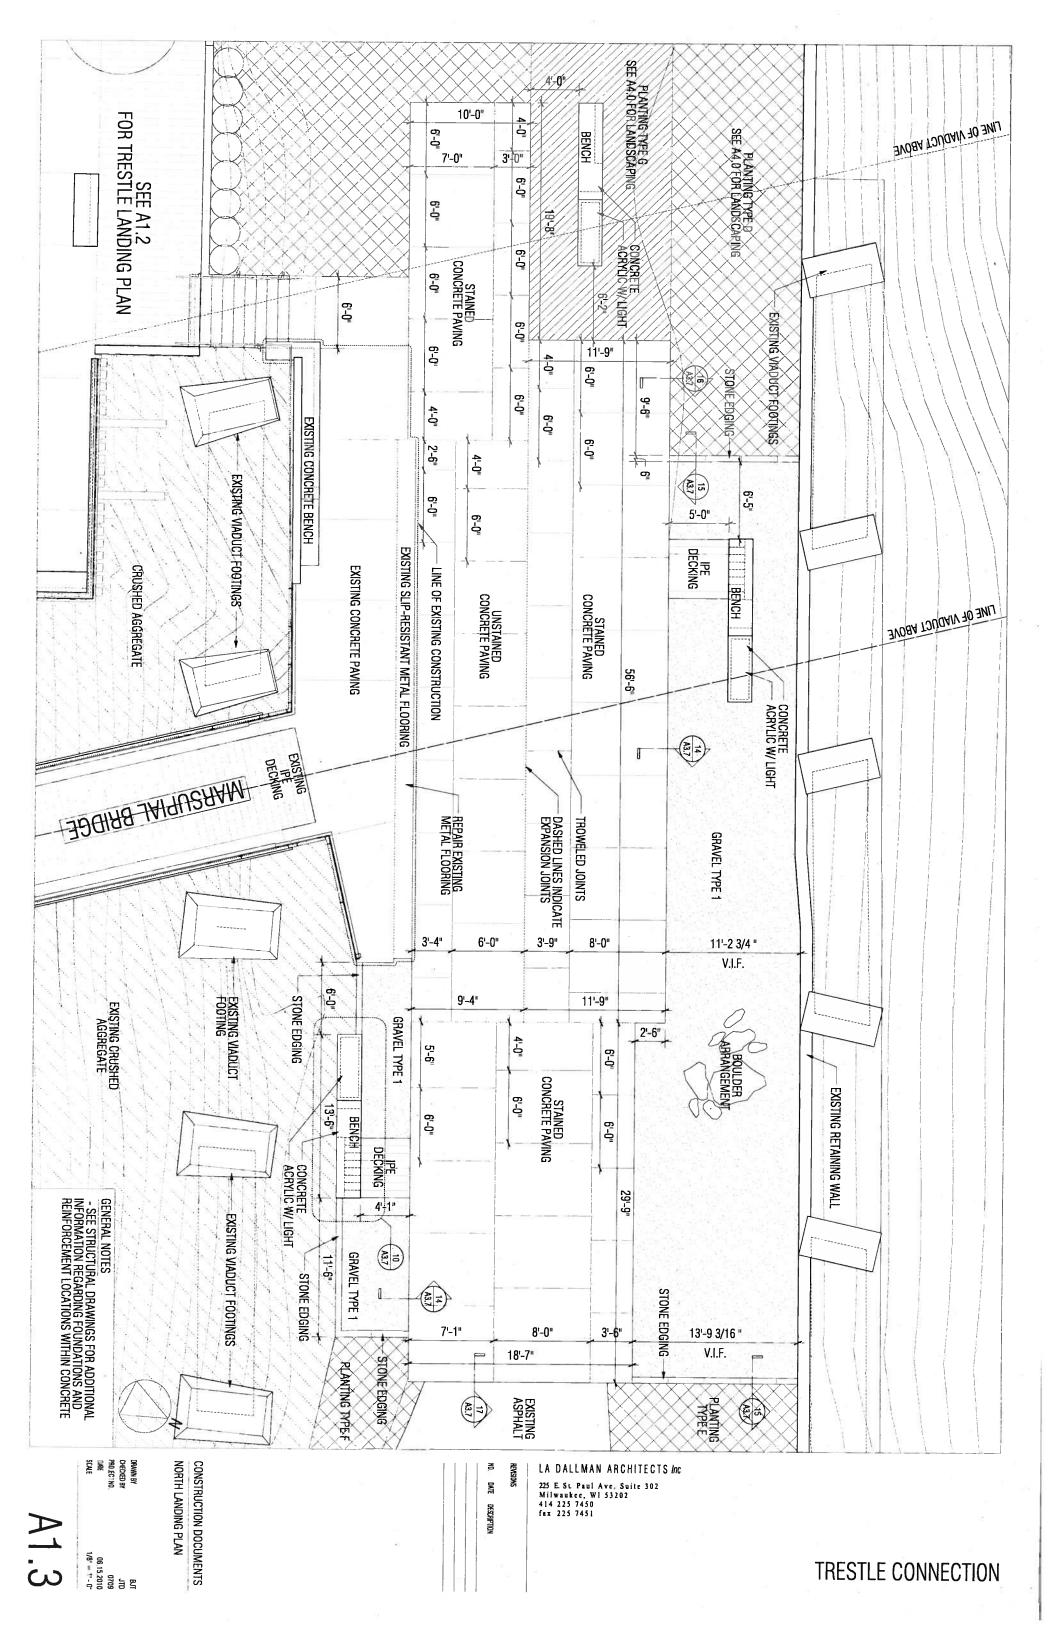
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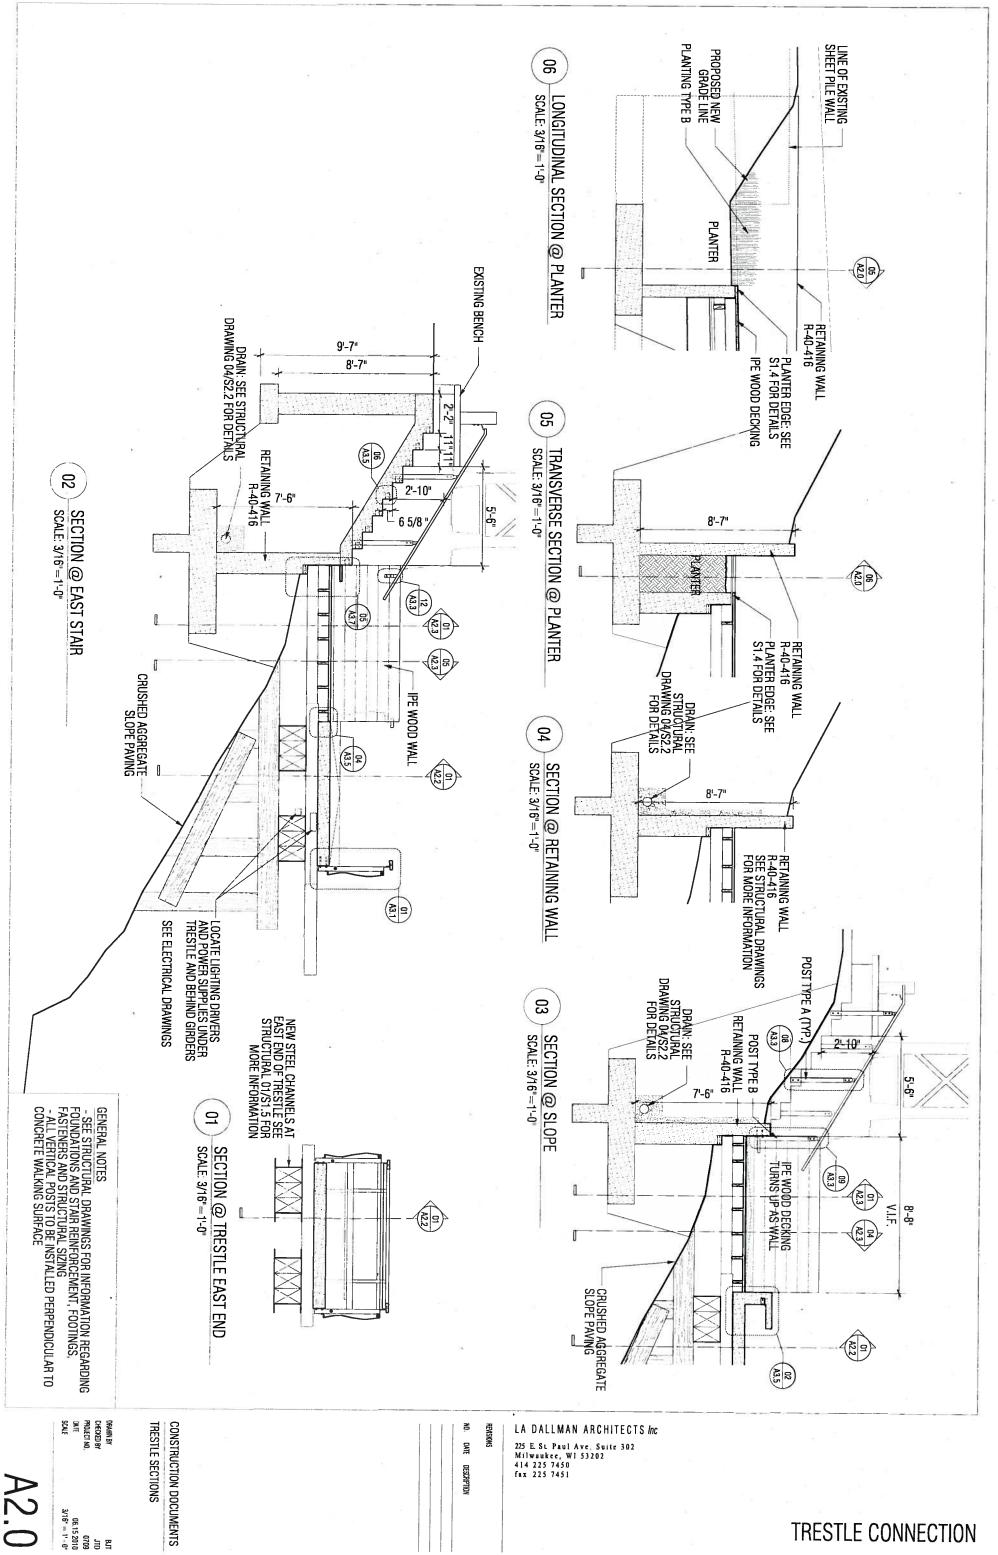
LA DALLMAN ARCHITECTS Inc 225 E. St. Paul Ave. Suite 302 Milwaukee, WI 53202 414 225 7450 fax 225 7451












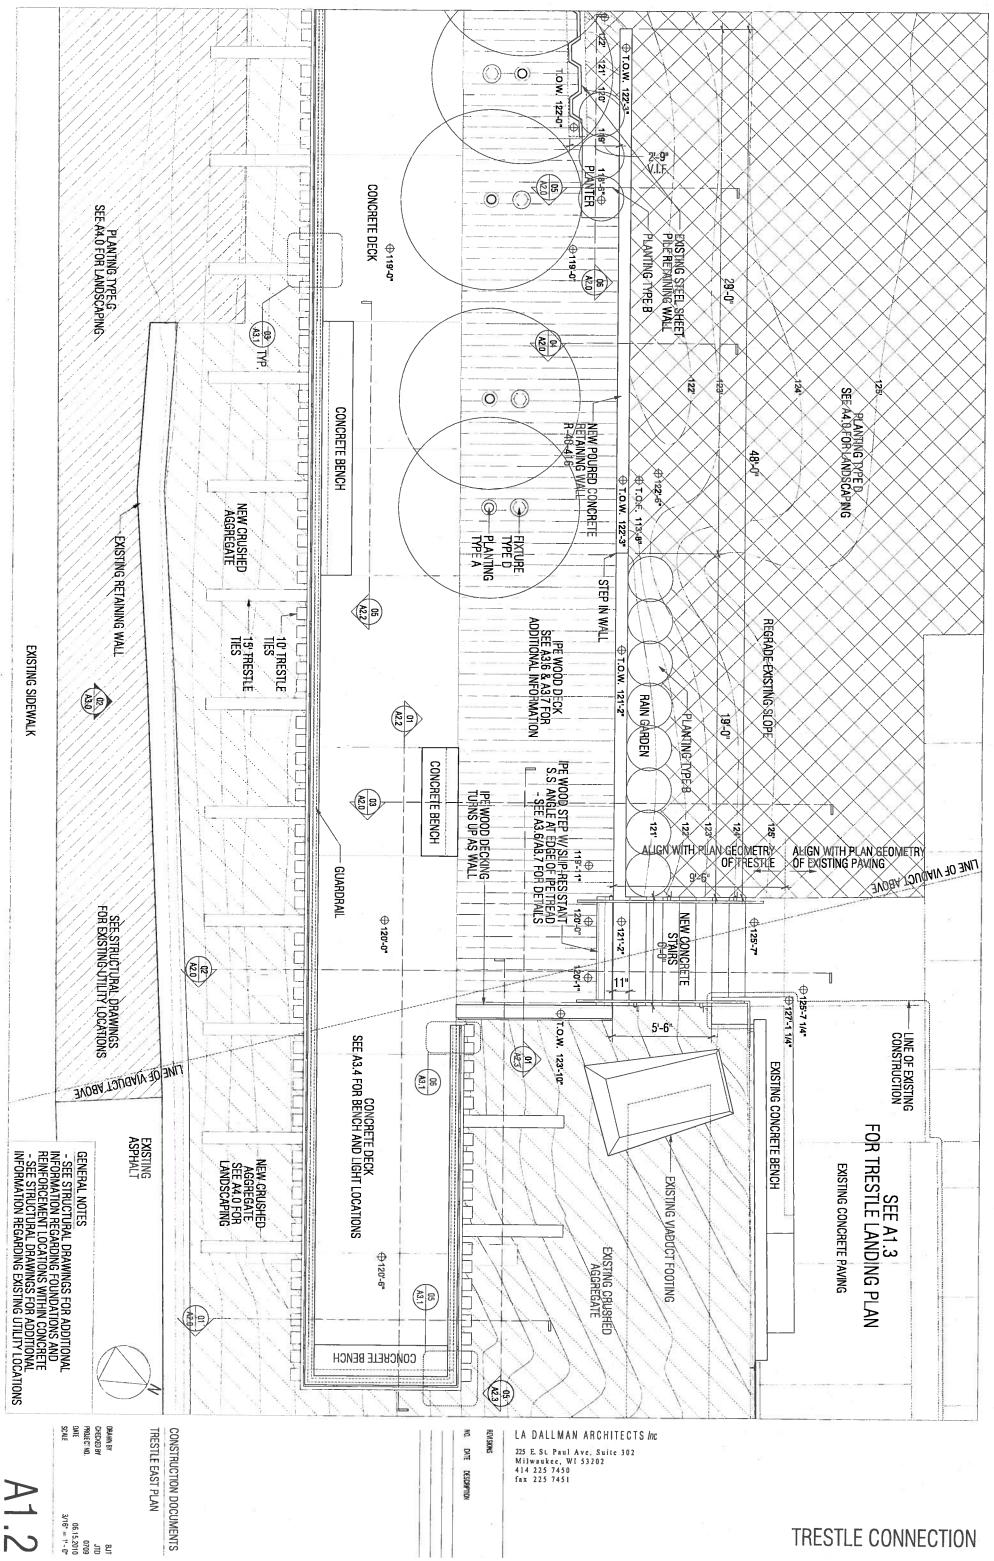


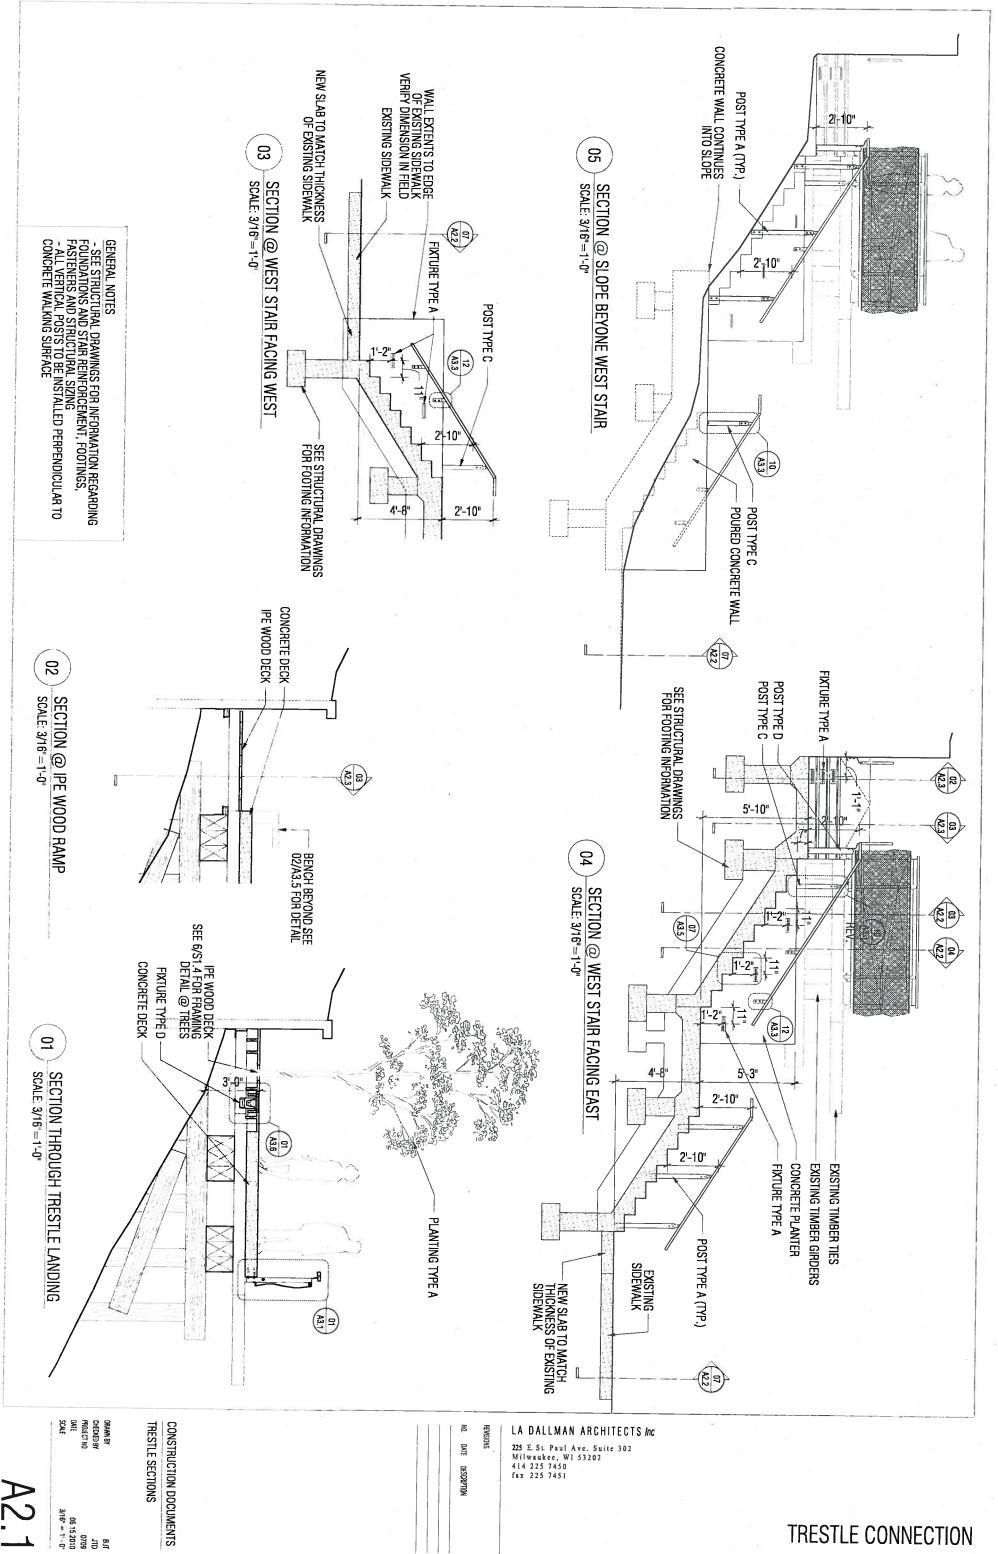


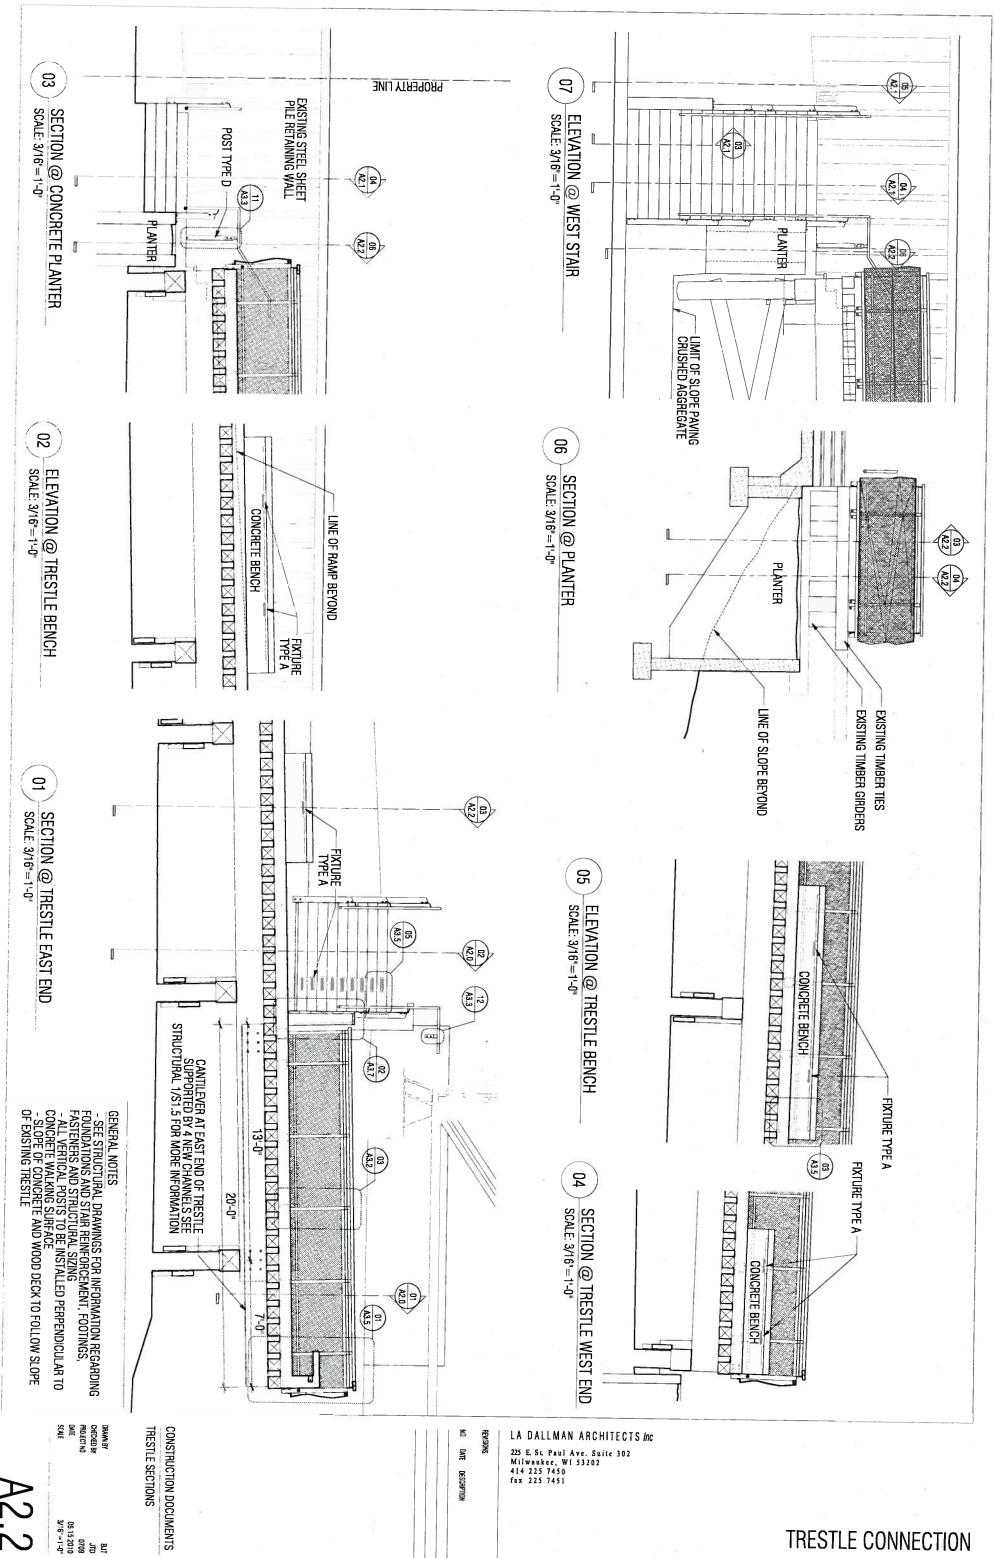


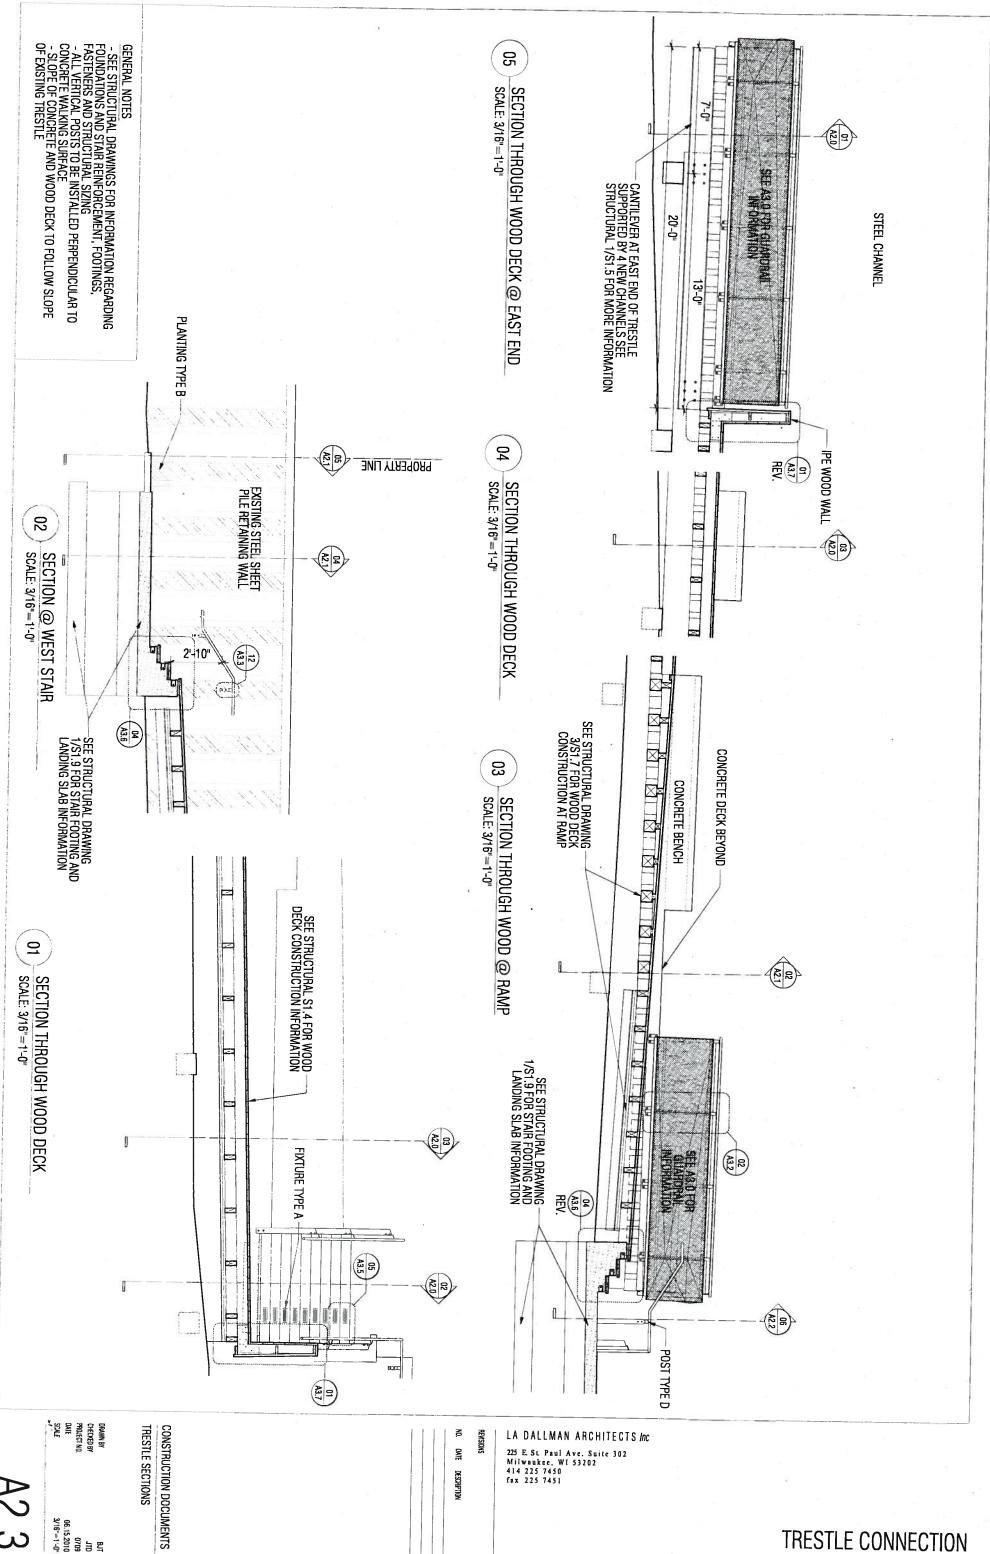


A2.3

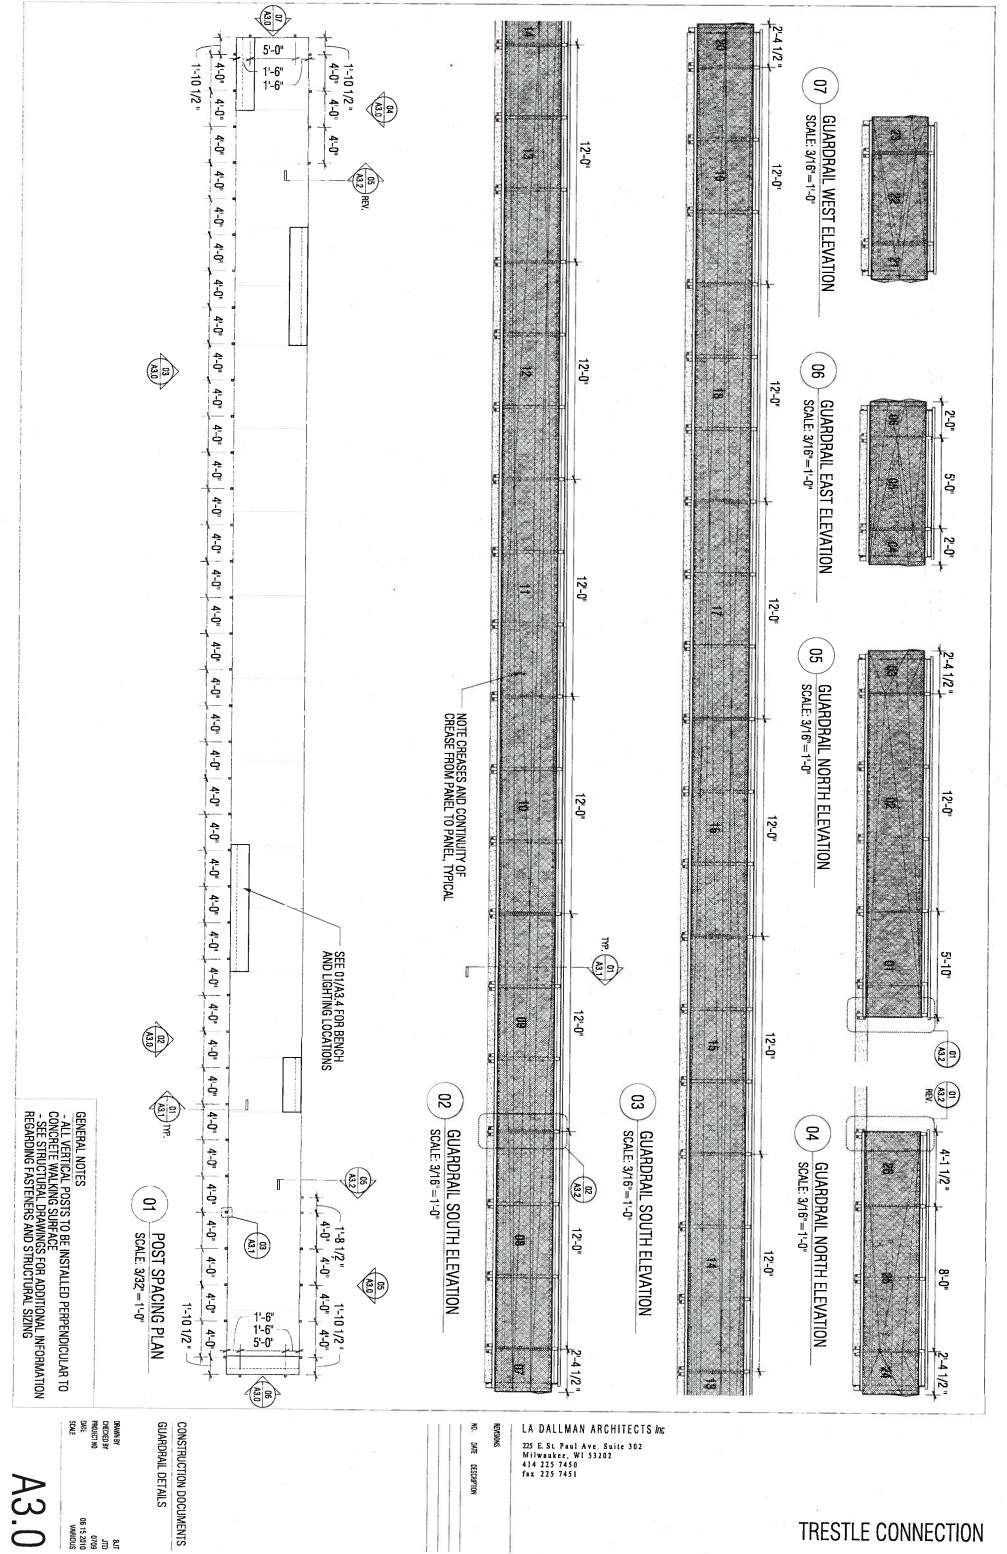

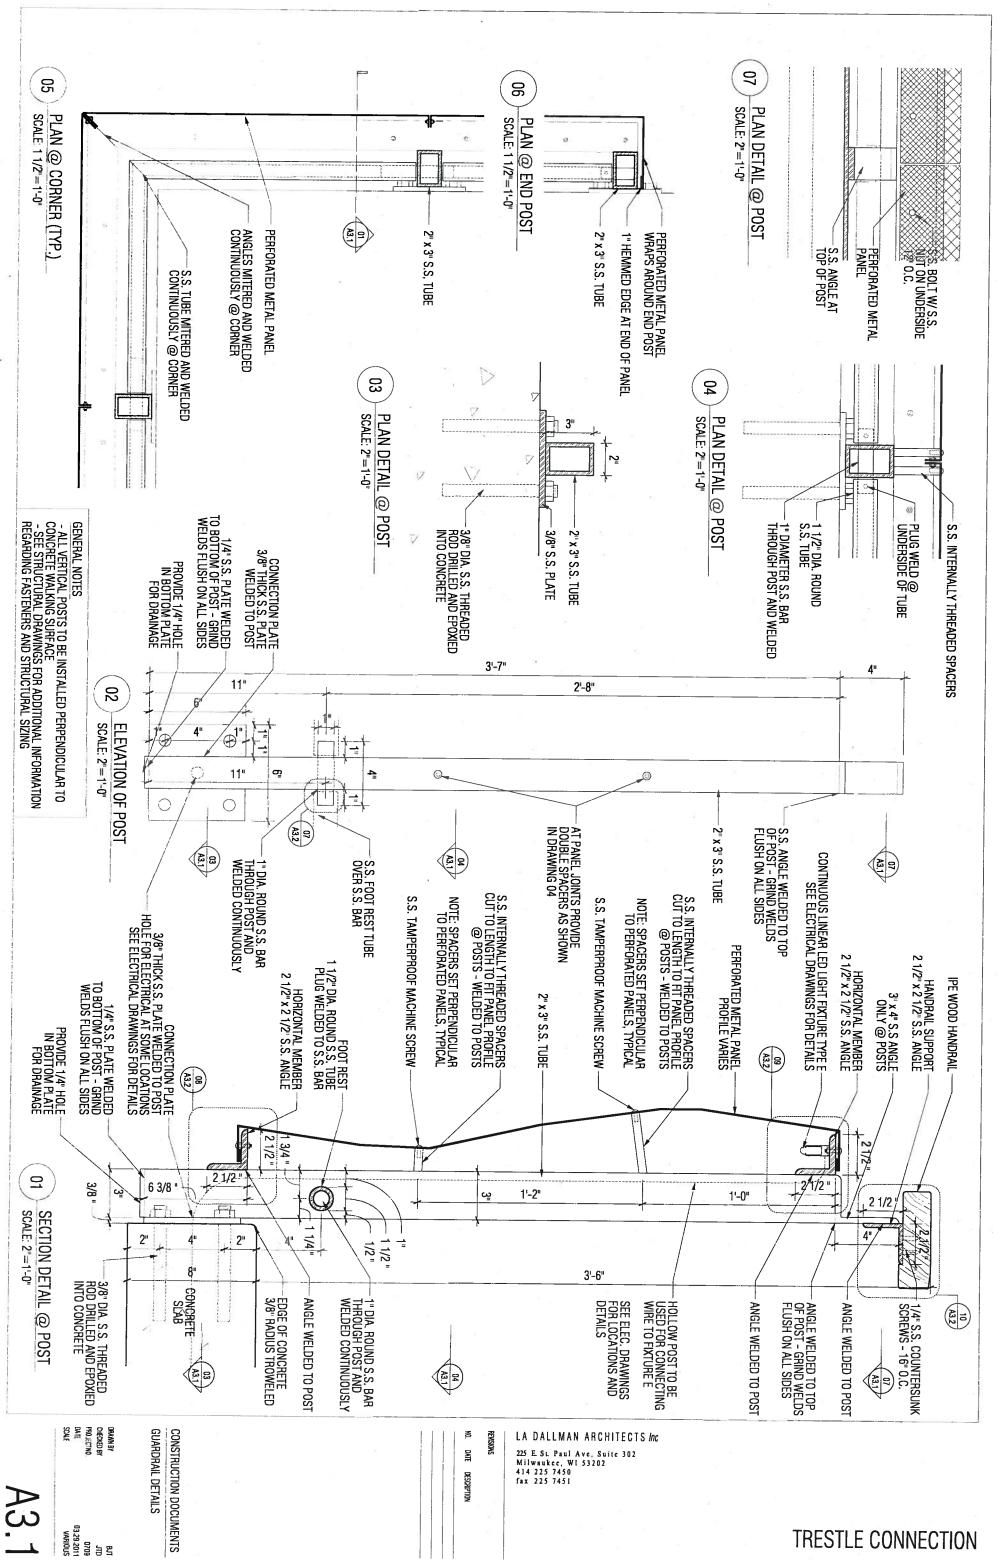


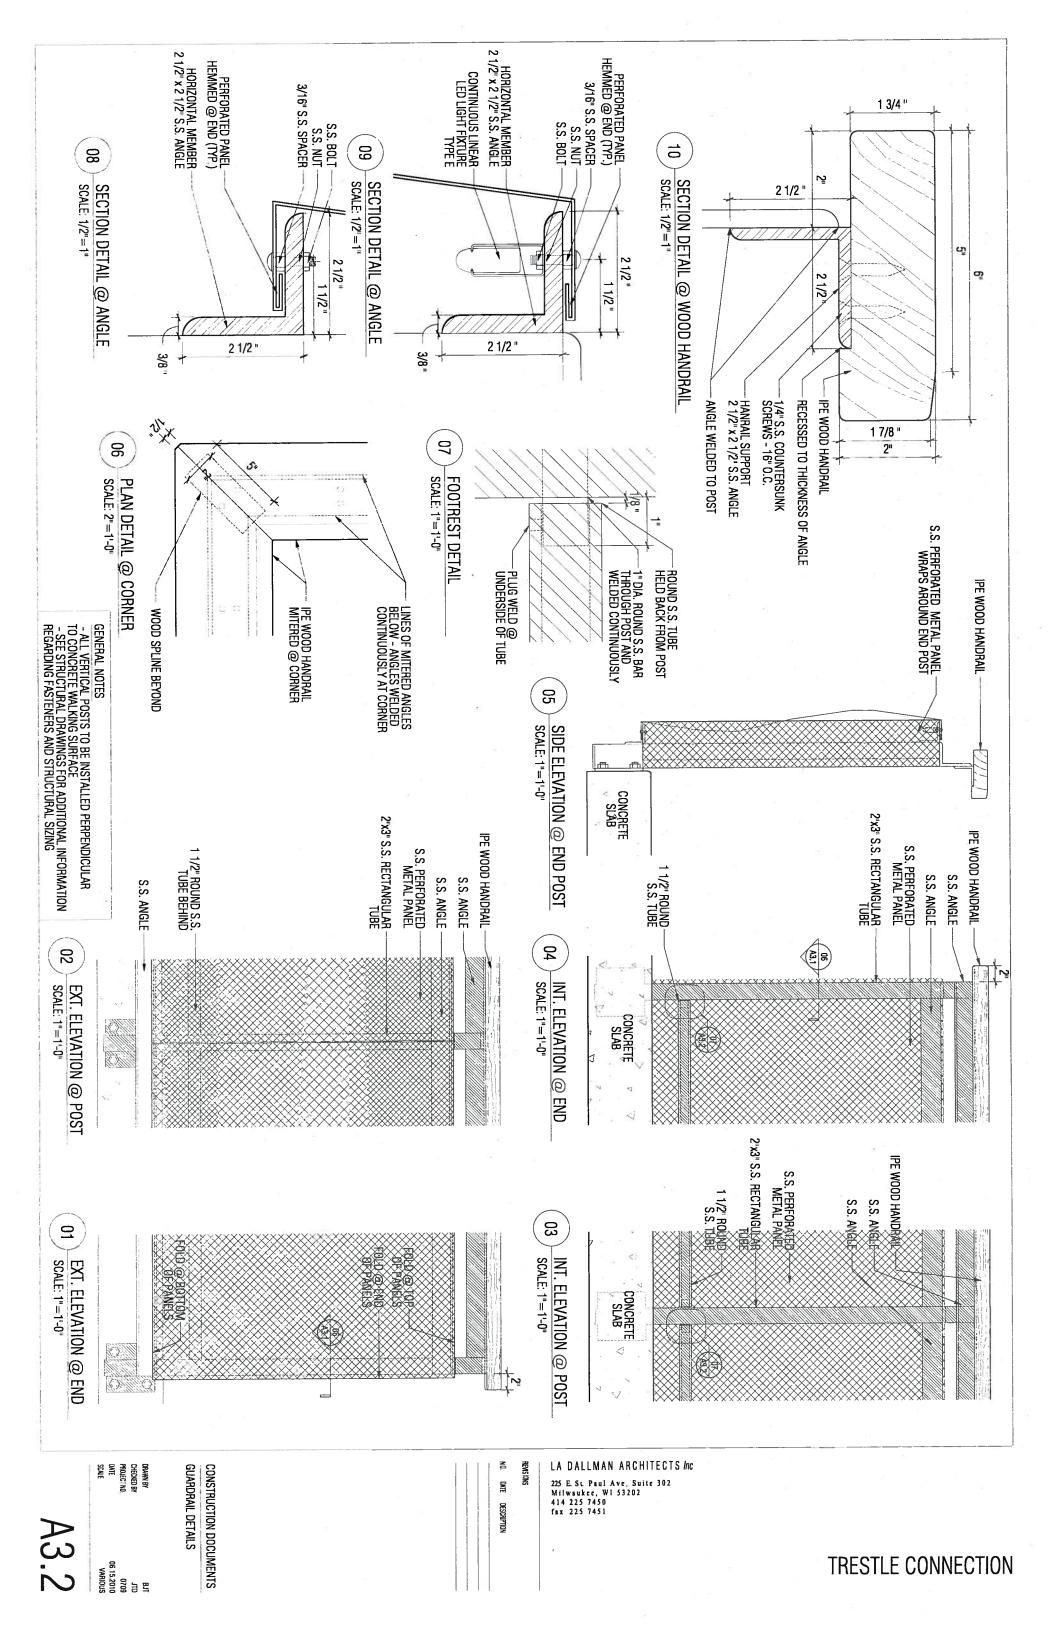

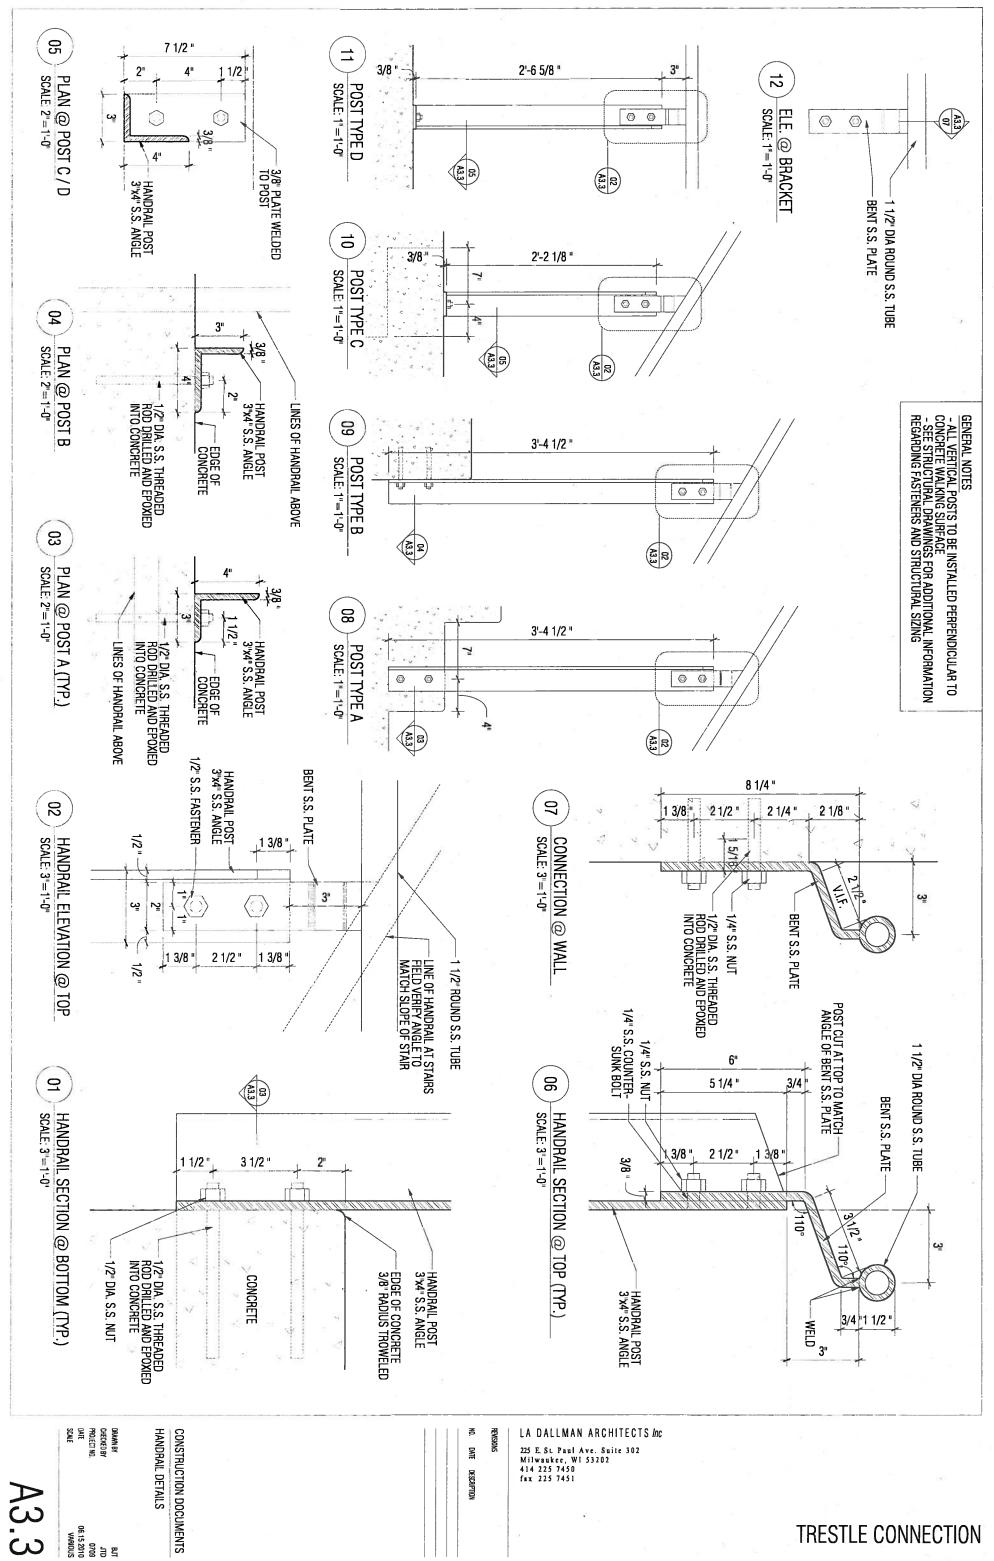



A3.3


TRESTLE CONNECTION

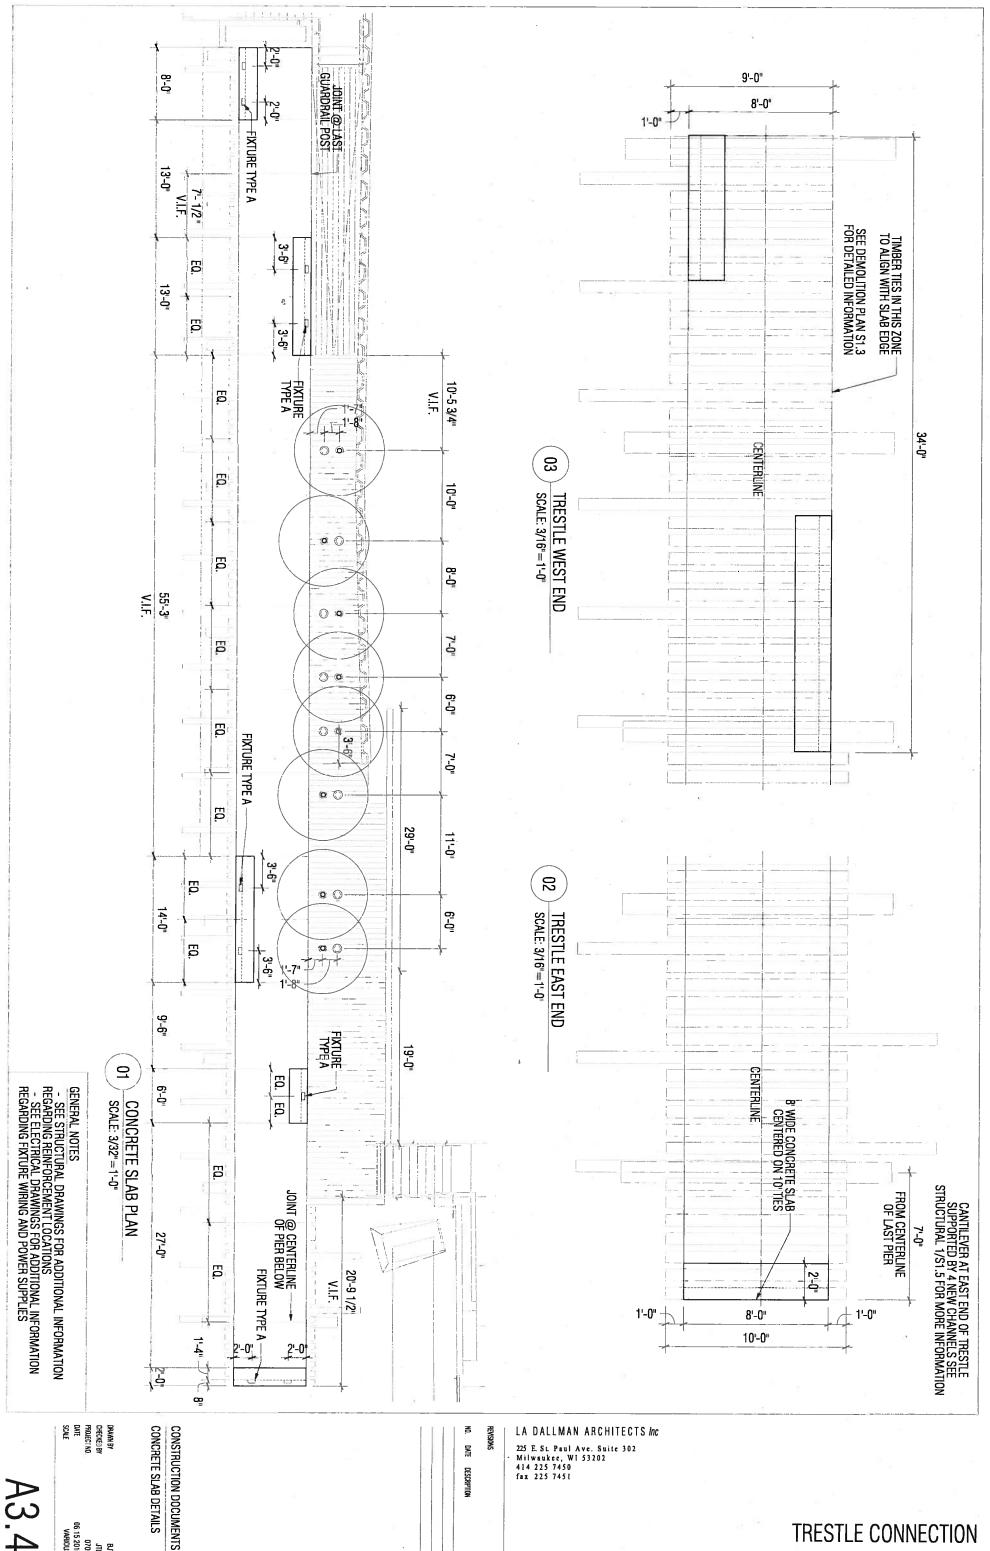


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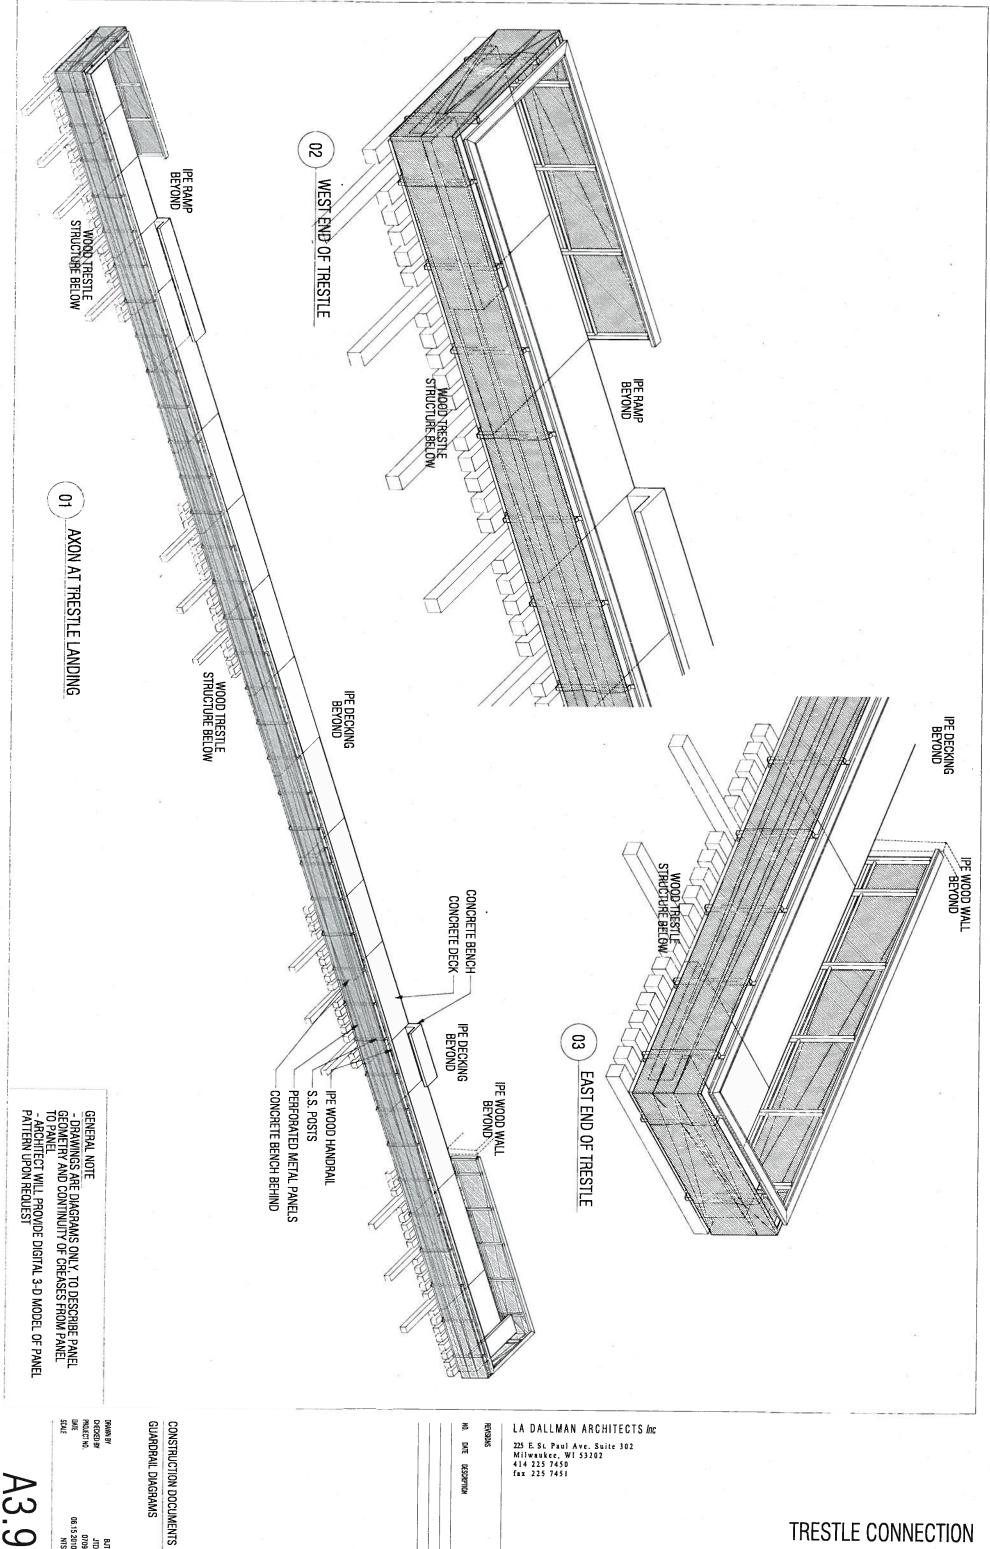


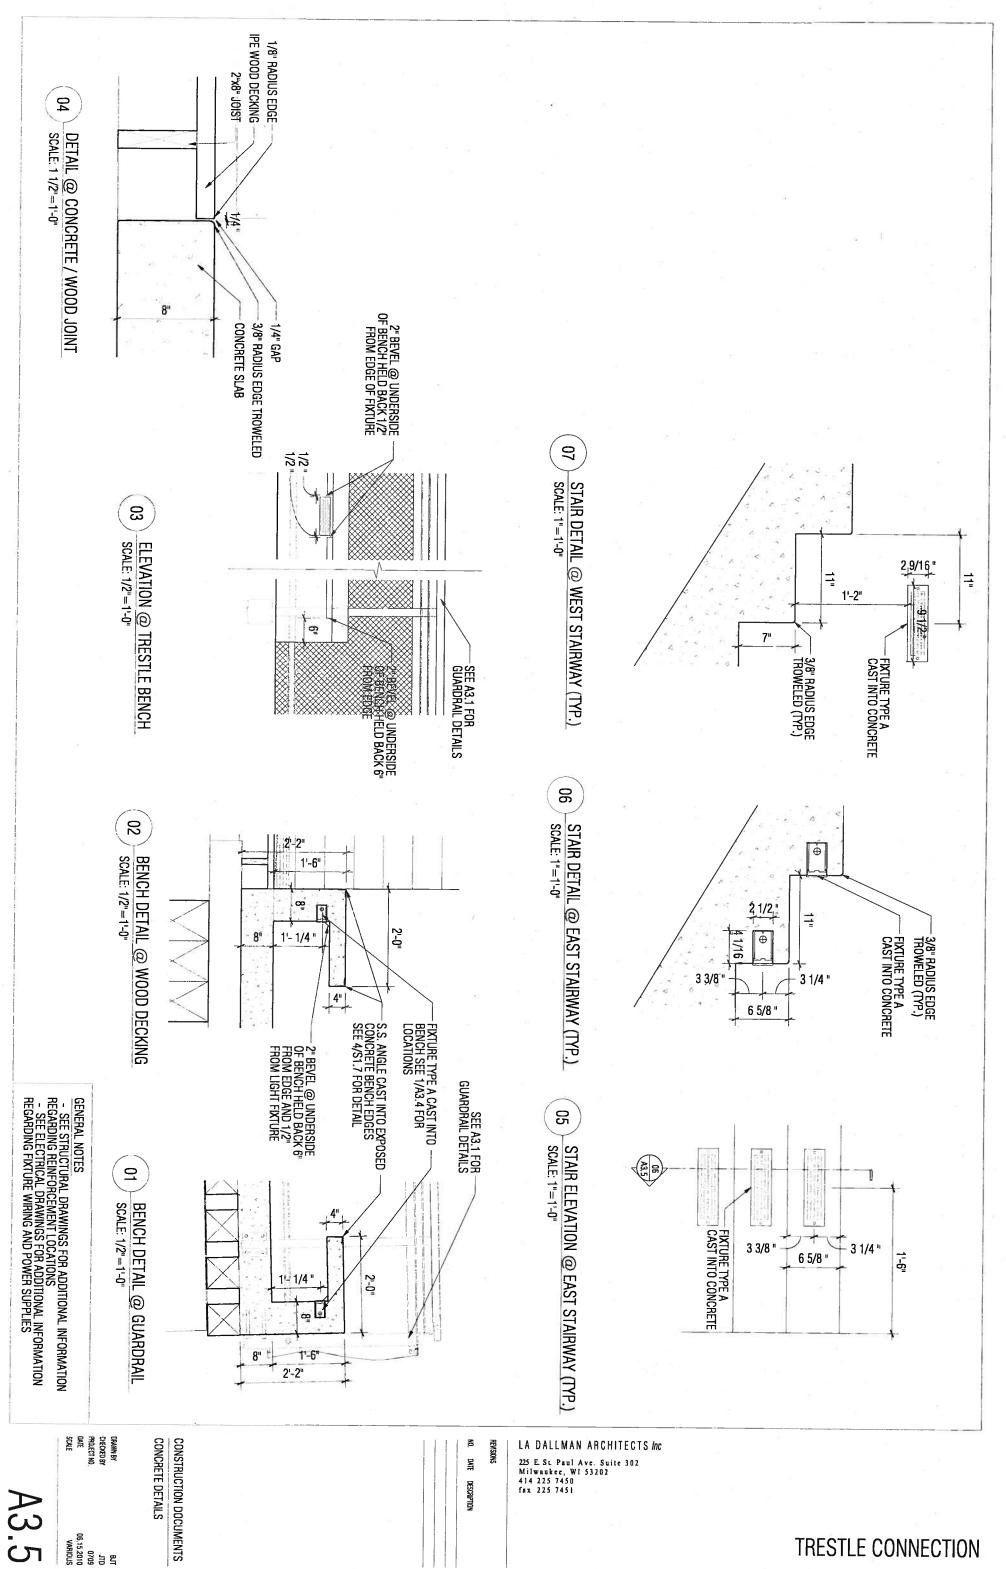


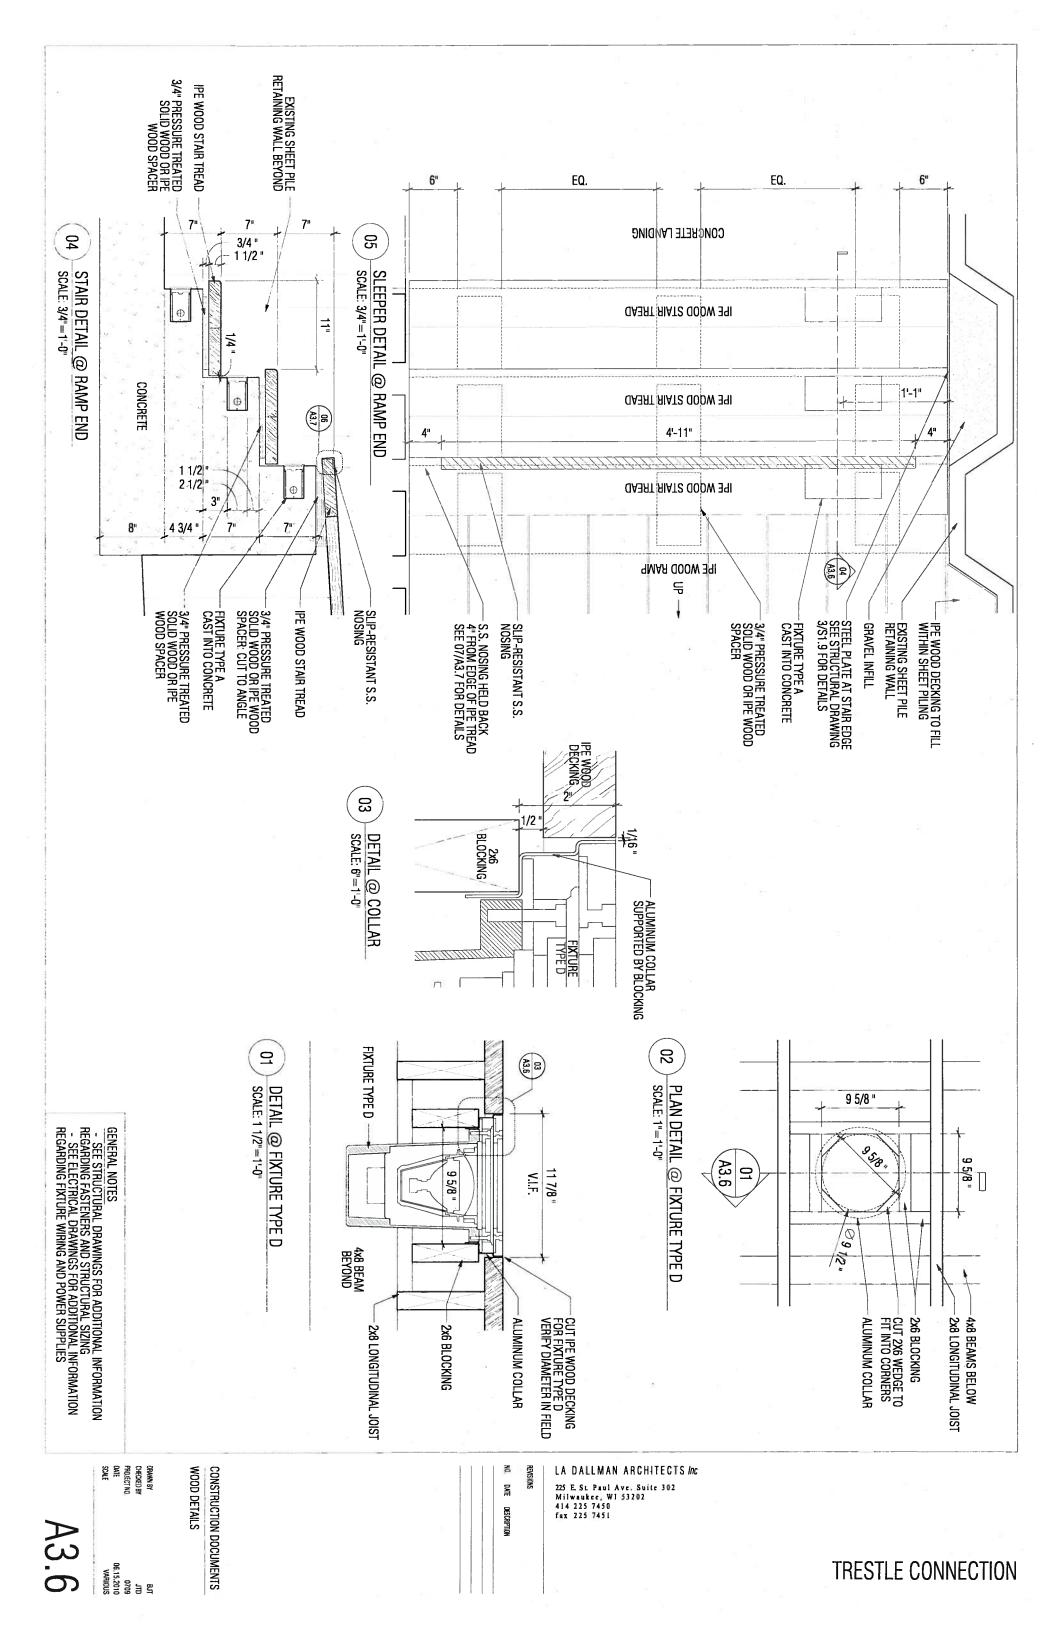

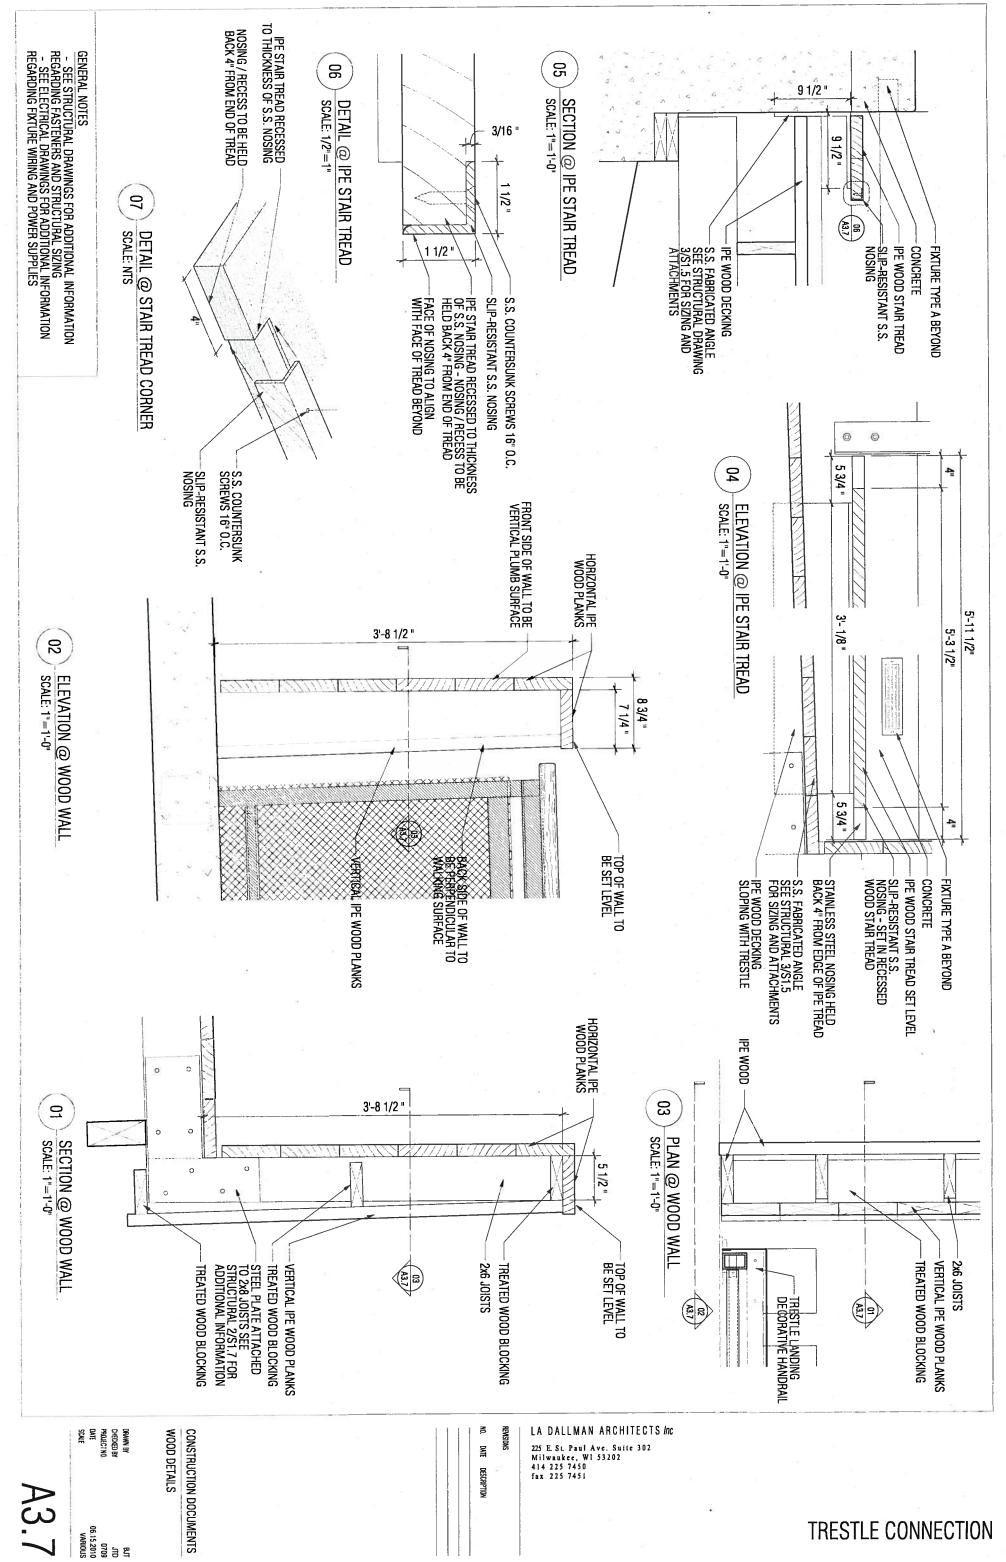

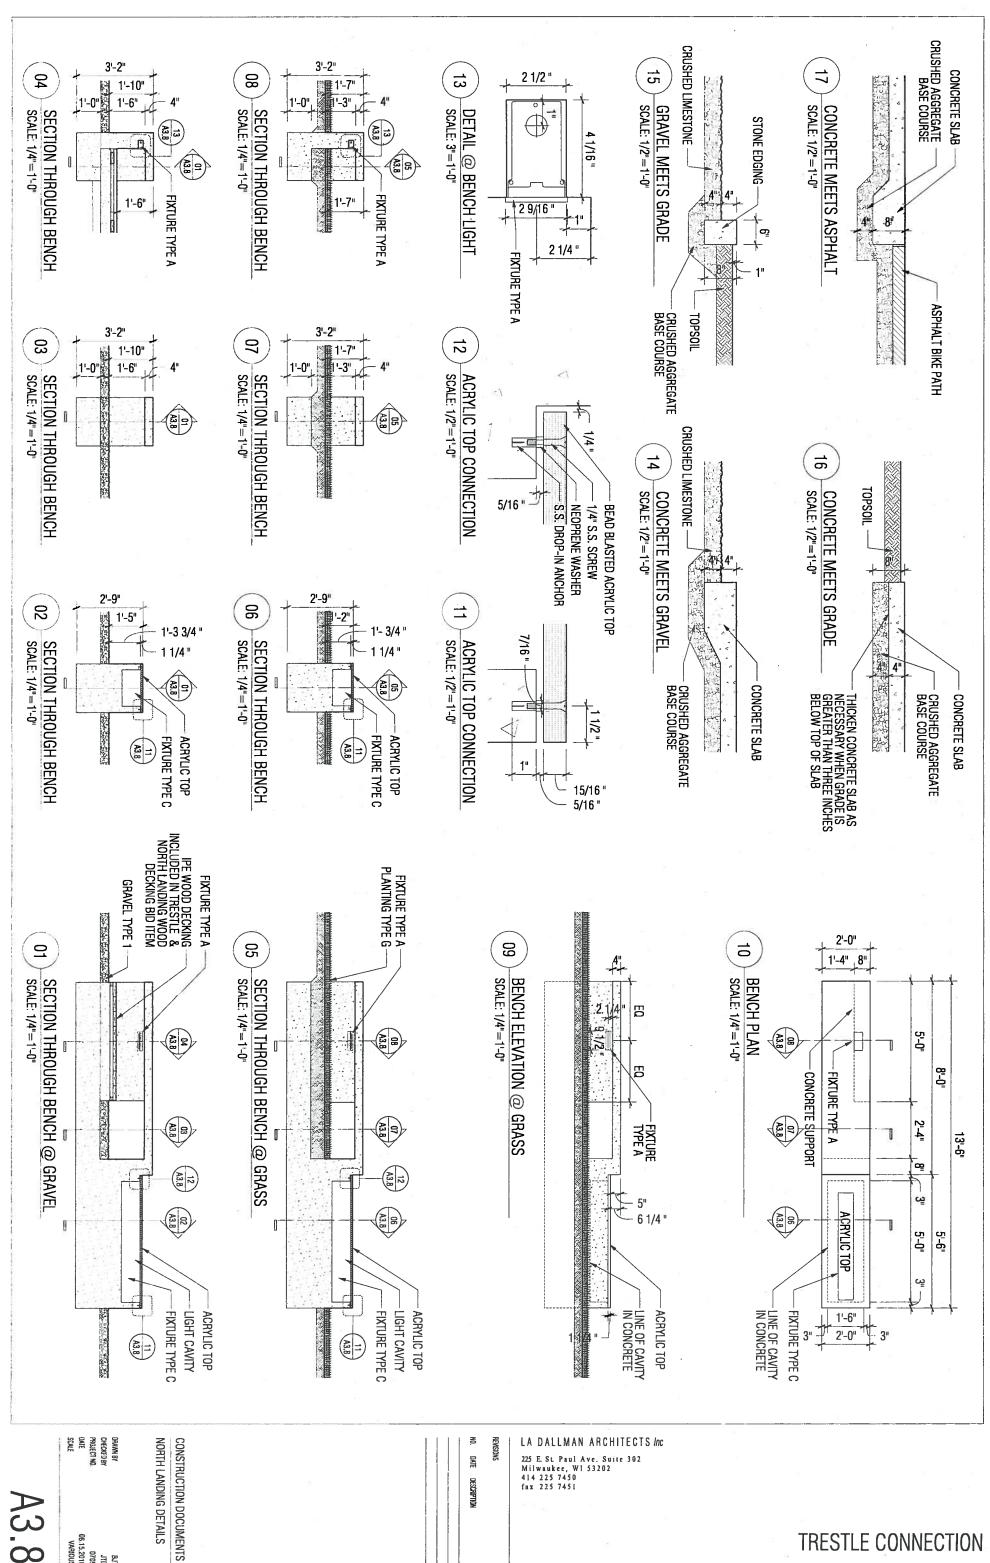BJT JTD 0709 06.15.2010 VARIOUS



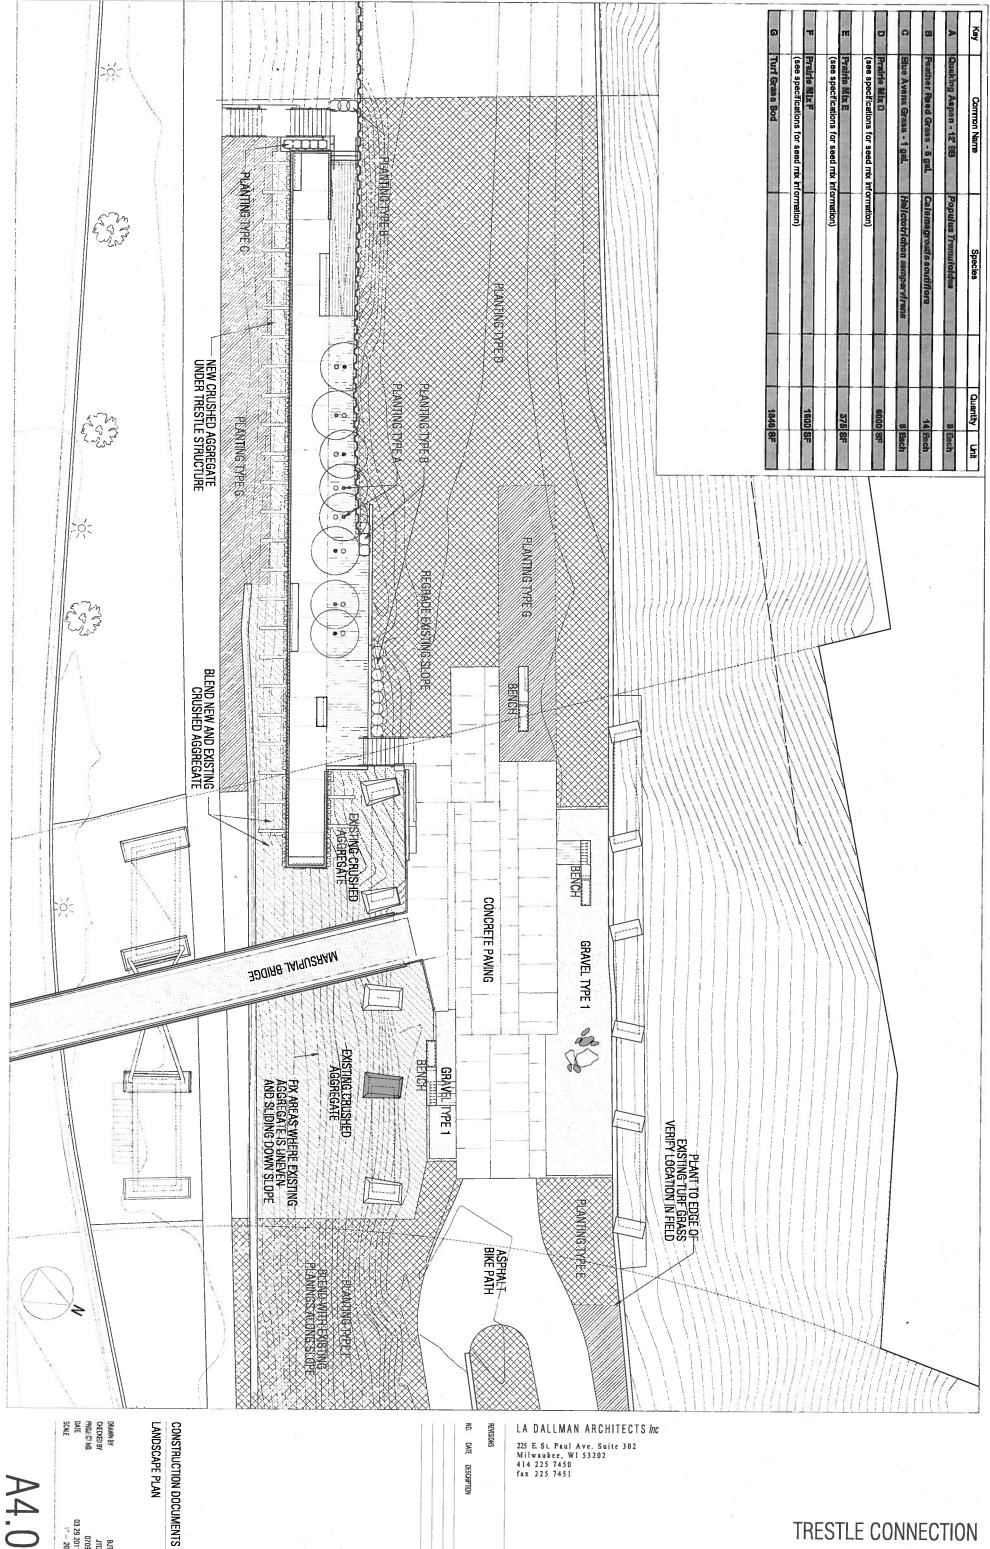

BJT JTD 0709 03.29.2011 1" = 20'

SPV.0060.09 SPV.0060.07 SPV.0060.10 SPV.0090.01 SPV.0060.08 SPV.0060.06 655,0601 652.0203 652.0101 652.0202 BID ITEM NUMBER 652.0201 **ECTRICAL** NON-METALLIC CONDUIT (SCHEDULE 80 PVC) - 1/2" TRADE SIZE ELECTRICAL WIRE, LIGHTING - #12 AWG (TYPE XHHW) NON-METALLIC CONDUIT (SCHEDULE 80 PVC) - 1 1/2" TRADE SIZE NON-METALLIC CONDUIT (SCHEDULE 80 PVC) - 3/4" TRADE SIZE METALLIC RIGID STEEL (RGS) CONDUIT - 3/4" TRADE SIZE LIGHTING CONTROL CABINET RECESSED BENCH AND STEP LIGHT LUMNAIRE - TYPE A (LED STEP LIGHT) IN-GRADE LIGHTING PULL BOX TRESTLE LANDING GUARD RAIL LUMNAIRE - TYPEE (LINEAR LED STRIP) RECESSED TREE UPLIGHT LUMINAIRE - TYPE D (IN GRADE UP-LIGHT) ACRYLIC BENCH LIGHT LUMINAIRE - TYPE C (ENCLOSED FLUORESCENT STRIP) ı **ESTIMATED** ITEM DESCRIPTION **QUANTITIES SCHEDULE** LINEAR FT LINEAR FT LINEAR FT LINEAR FT LINEAR FT LINEAR FT EACH EACH EACH EACH EACH STINU MUNAUD 3165 898 175 200 54 00 29 w _ œ w

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			TVSS DEVICE	SPARE	SPARE	SPARE	CONTACTOR/TIMECLOCK CKT	CIRCUIT #Z	GUARD RAIL LIGHTING	CITY CITY CITY CITY CITY CITY CITY CITY	TRESTLE LIGHTING		LOAD DESCRIPTION	E SURFACE IN CABINET	AMPS MAIN CROUT BREAKER		
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GENERAL ELECTRICAL NOTE

- ALL NEW CONDUIT INSTALLED BELOW GRADE, CONCEALED IN THE CONCRETE BENCHES OR INSTALLED WITHIN CONCRETE SHALL BE SCHEDULE 80 NON-METALLIC PVC CONDUIT.
- ALL NEW CONDUITS INSTALLED ABOVE GRADE OR EXPOSED TO WEATHER (IF ANY) SHALL BE RIGID STEEL CONDUIT. THE USE OF ABOVE GRADE CONDUITS SHALL BE MINIMIZED AS MUCH AS

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- ALL NEW CONDUITS INSTALLED BELOW THE NEW TRESTLE CONNECTOR PLATFORM SHALL BE INTERMEDIATE METALLIC CONDUIT (IMC) OR RIGID STEEL (RGS) CONDUIT.
- ALL FINAL CONNECTIONS FROM JUNCTION BOXES TO LUMINAIRES OR LED DRIVERS SHALL BE DOI WITH #12 AWG WIRING IN FLEXIBLE LIQUIDTIGHT CONDUIT OR WITH SCHEDULE 80 NON-METALLIC PVC CONDUIT, AS APPROPRIATE FOR THE INSTALLATION LOCATION. UMINAIRES OR LED DRIVERS SHALL BE DONE
- ALL NEW WIRING INSTALLED AS PART OF THIS PROJECT SHALL BE TYPE "XHHW-2" FOR UNDERGROUND OR OUTDOOR INSTALLATIONS. SOLID COPPER CONDUCTORS.
- WIRING FOR LOW-VOLTAGE DC CABLING (FOR LED LUMINARIES) SHALL BE #14 AWG MINIMUM. SIZE ALL LOW-VOLTAGE DC CABLING AS RECOMMENDED BY THE LUMINAIRE MANUFACTURER.

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ALL EXPOSED CONDUIT AND JUNCTION BOXES SHALL BEXISTING STRUCTURE COLOR. THE INTENT IS TO CONC 3E PRIMED AND PAINTED TO MATCH THE CEAL CONDUIT FROM VIEW TO THE EXTEND

LA DALLMAN ARCHITECTS Inc

225 E. St. Paul Ave. Suite 302 Milwaukee, WI 53202 414 225 7450 fax 225 7451

- ALL NUTS, BOLTS, UNITSTRUT, THREADED RODS, UNISTRUT STRAPS, ANCHORS AND ROD COUPLINGS SHALL BE STAINLESS STEEL.
- 9 ALL CONDUITS INSTALLED BELOW GRADE SHALL BE INSTALLED GRADE. TALLED AT A DEPTH NO LESS THAN 24"

REVISIONS

DATE

DESCRIPTION

<u></u> INSTALL EXPANSION FITTINGS FOR ANY RIGID CONDUIT INSTALLED IN AREAS LOCATED EXPOSED TO WEATHER. INSTALLATIONS THAT EXCEED 25-FEET AND

PROJECT SCOPE NOTES

- A REFER TO THE ARCHITECTURAL DRAWINGS FOR THE EXACT MOUNTING LOCATION OF ALL LIGHTING LUMINAIRES INSTALLED DURING THIS PROJECT.
- ₽ ALL LIGHTING LUMINAIRES ARE TO BE FURNISHED AND INSTALLED BY THE ELECTRICAL CONTRACTOR. PROVIDE ALL ACCESSORIES FOR EACH LUMINAIRE AS REQUIRED FOR A COMPLETE INSTALLATION.
- ? ALL LUMINAIRES INSTALLED AS PART OF THIS PROJECT SHALL BE WIRED TO TWO (2) 240-VOLT LIGHTING CIRCUITS FURNISHED FROM THE NEW LIGHTING PANEL "A" INSTALLED IN THE NEW LIGHTING CONTROL CABINET ENCLOSURE, REFER TO SHEET E1.0 FOR LOCATION.
- _D PROVIDE A NEW 100-AMPERE, 120/240-VOLT, 1-PHASE, 3-WIRE ELECTRICAL SERVICE FROM WE ENERGIES. THE MAIN CONTACT AT WE ENERGIES FOR THIS PROJECT SHALL BE JIM WARD AT TELEPHONE (414) 449-3013, EMAIL ADDRESS: jim.word@we-energies.com
- iп COMPLETE INSTALLATION. THE ELECTRICAL CONTRACTOR SHALL INSTALL ALL NEW LIGHTING LUMINAIRES AS SHOWN IN T DRAWING SET. THAT SHALL INCLUDE ALL REQUIRED RACEWAYS, BOXES, WIRING, ETC. FOR A LIGHTING LUMINAIRES AS SHOWN IN THIS

3) PANEL TO BE LOCATED WITHIN THE "LICHTING CONTROL CABINET" ASSEMBLY AS DETAILED ON THE DRAWINGS. REFER TO DETAIL ON SHEET E1.5


2) PROVIDE CIRCUIT BREAKER QUANTITIES AS SHOWN ON THIS SCHEDULE 1) PANEL SHALL BE RATED FOR USE AS SERVICE BYTRANCE EQUIPMENT

THE ELECTRICAL CONTRACTOR SHALL BE RESPONSIBLE SURFACES (ASPHALT OR CONCRETE) AS REQUIRED TO SHOWN IN THIS DRAWING SET. COMPLETE THE INSTALLATION WORK AS FOR ALL CUTTING AND PATCHING OF PAVED

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DRAWN BY CHECKED BY PROJECT NO. DATE SCALE ELECTRICAL NOTES AND SCHEDULES CONSTRUCTION DOCUMENTS

RWW RWW 0709 03.28.2011 1" = 60-0"

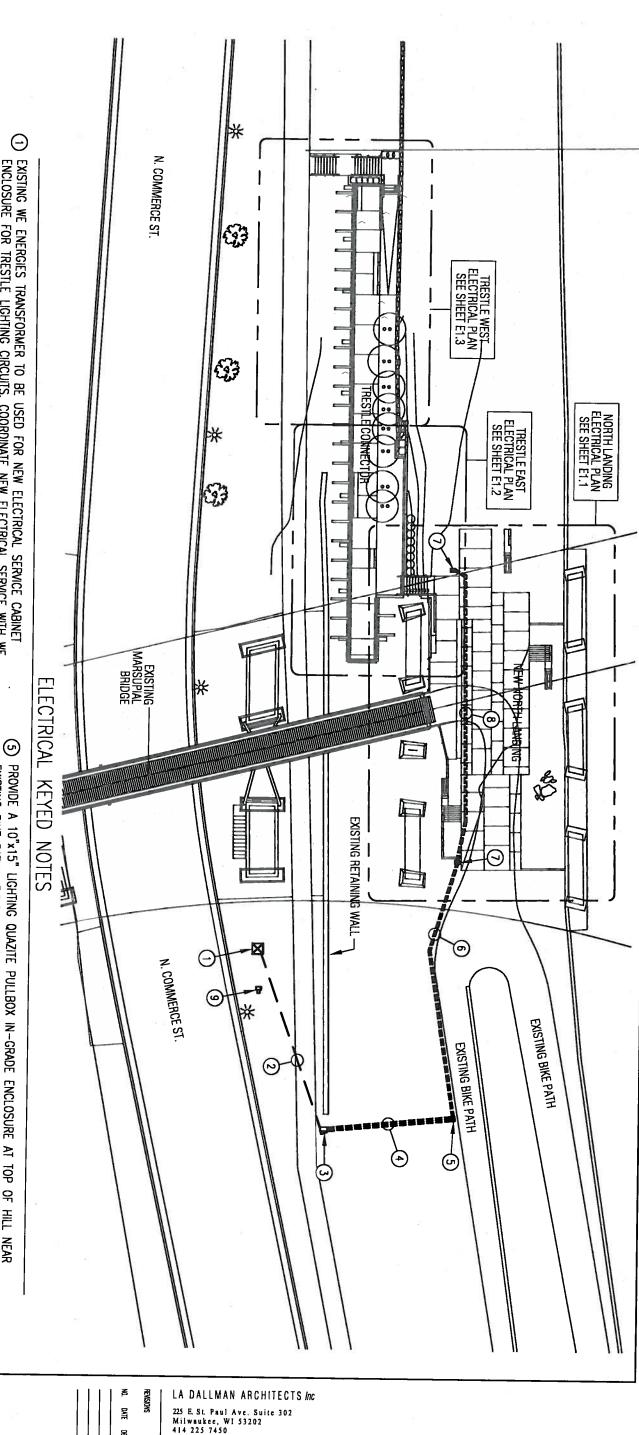

- <u>(0)</u> SERVICE LATERAL CONDUCTORS FROM TRANSFORMER TO METERING PEDESTAL AT LIGHTING CONTROL CABINET ENCLOSURE TO BE FURNISHED AND INSTALLED BY WE ENERGIES AS PART OF ELECTRICAL SERVICE INSTALLATION. COORDINATE IN FIELD WITH WE ENERGIES AS REQUIRED. PROVIDE A 1 1/2" SCHEDULE 80 PVC CONDUIT STUB 5-FEET FROM SERVICE ENCLOSURE CONCRETE PAD FOR USE BY WE ENERGIES FOR CABLING SERVICE ENTRANCE INTO LIGHTING CONTROL CABINET. EXISTING WE ENERGIES TRANSFORMER TO BE USED FOR NEW ELECTRICAL SERVICE CABINET ENCLOSURE FOR TRESTLE LIGHTING CIRCUITS. COORDINATE NEW ELECTRICAL SERVICE WITH WE AS REQUIRED.
- Θ ELECTRICAL LIGHTING CONTROL CABINET ENCLOSURE THAT CONTAINS PANEL "A" AND CONTROLS (CONTACTOR/TIMECLOCK) TO SERVE THE LIGHTING ON THIS PROJECT. ALL EQUIPMENT TO BE FURNISHED AND INSTALLED BY THE ELECTRICAL CONTRACTOR AS PART OF LIGHTING CONTROL CABINET. REFER TO THE SPECIFICATIONS AND SHEET E1.5 FOR A MORE DETAILED VIEW OF CABINET. REFER TO THE S LIGHTNIG CONTROL CABINET.

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(4) PROVIDE THREE (3) 3/4" SCHEDULE 80 PVC CONDUITS AT +24" BELOW FINISHED GRADE FOR SECONDARY CONDUCTORS TO LIGHTING LUMINAIRES ON THE NORTH LANDING AND TRESLE PLAZA. ROUTE CONDUITS UP SLOPE LOCATED TO WEST OF SERVICE CABINET TO THE IN-GRADE QUAZITE PULL BOX LOCATED ON GRADE LEVEL WITH BIKE PATH. CONDUITS TO PROVIDE CABLING FOR THIS PROJECT AND FUTURE CABLING PATHWAY FOR ANY POTENTIAL FUTURE LIGHTING CIRCUITS ON THIS

> PROVIDE A 10"x15" LIGHTING QUAZITE PULLBOX IN-GRADE ENCLOSU PULLBOX DETAIL" EXISTING BIKE PATH. FIELD VERIFY EXACT LOCATION. REFER TO OSURE AT TOP OF HILL NEAR SHEET E1.5 FOR "QUAZITE E1.5 FOR "QUAZITE

> > DESCRIPTION

fax 225 7451

- PROVIDE TWO (2) 3/4" SCHEDULE 80 PVC CONDUITS AT 24" BELOW GRADE FOR LIGHTING CIRCUITS TO THE NORTH LANDING PLAZA AND TRESTLE LIGHTING AS SHOWN IN THIS DRAWING SET.
- PROVIDE A 10"x15" LIGHTING QUAZITE PULLBOX IN-GRADE ENCLOSURE ON EACH SIDE OF PLAZA WITHIN A NON-PAVED AREA AS SHOWN. FIELD VERIFY EXACT FINAL LOCATION.
- PROVIDE TWO (2) 3/4" SCHEDULE 80 PVC CONDUITS AT 24" BELOW GRADE ACROSS THE NORTH LANDING PLAZA. ONE FOR CURRENT PROJECT AND ONE SPARE FOR FUTURE USE. CONDUITS TO BE RUN IN AREAS WITH NEW PAVING AS PART OF THIS PROJECT. DO NOT CROSS AREAS WHERE EXISTING PAVING SHALL REMAIN. COORDINATE WITH ARCHITECTURAL DIFFERENCE OF EXISTING AND NEW PAVED SURFACES IN THIS AREA. ALL NEW I FROM THESE PULLBOX LOCATIONS. REFER TO ELECTRICAL SHEETS EINFORMATION. DRAWINGS A1.3 FOR LOCATIONS LIGHTING CIRCUITS TO BE FED E1.1 THRU E1.3 FOR MORE
- EXISTING ELECTRICAL METERING PEDESTAL AND TELEPHONE PEDESTAL DEVICES ARE NOT ASSOCIATED WITH THIS PROJECT. TO REMAIN AS IS. THESE

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MATRIX GROUP ENGINEERING CONSULTANTS


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CONSTRUCTION DOCUMENTS VERALL SITE PLAN -LECTRICAL


RWW RWW 0709 03.28.2011 1" = 30"-0"

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RWW RWW 0709 03.28.2011 1/8" = 1'-0"

MATRIX GROUP

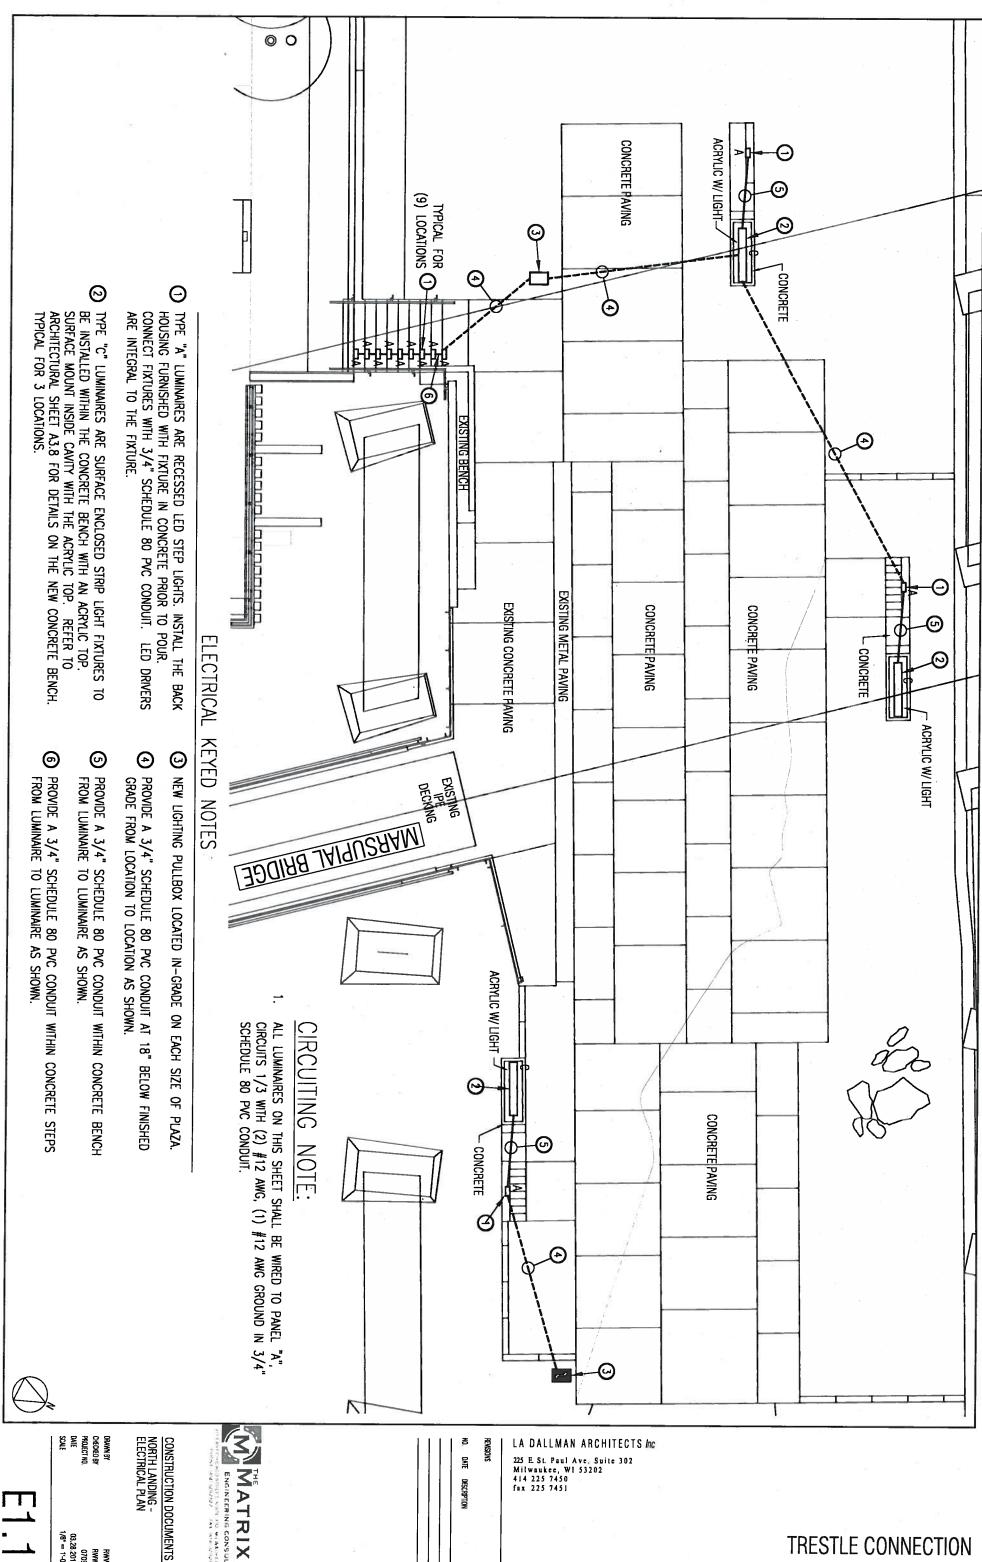

- ALL LUMINAIRES (TYPE A, TYPE D) ON THIS SHEET SHALL BE WIRED TO PANEL "A", CIRCUIT 1/3 (240-VOLT) WITH (2) #12 AWG, (1) #12 AWG GROUND IN 3/4" SCHEDULE 80 PVC CONDUIT.
- THE LOCATION AND INSTALLATION INFORMATION FOR THE GUARDRAIL LIGHT FIXTURE (TYPE E SPV.0090.01) IS SHOWN IS INDICATED ON SHEET E1.4
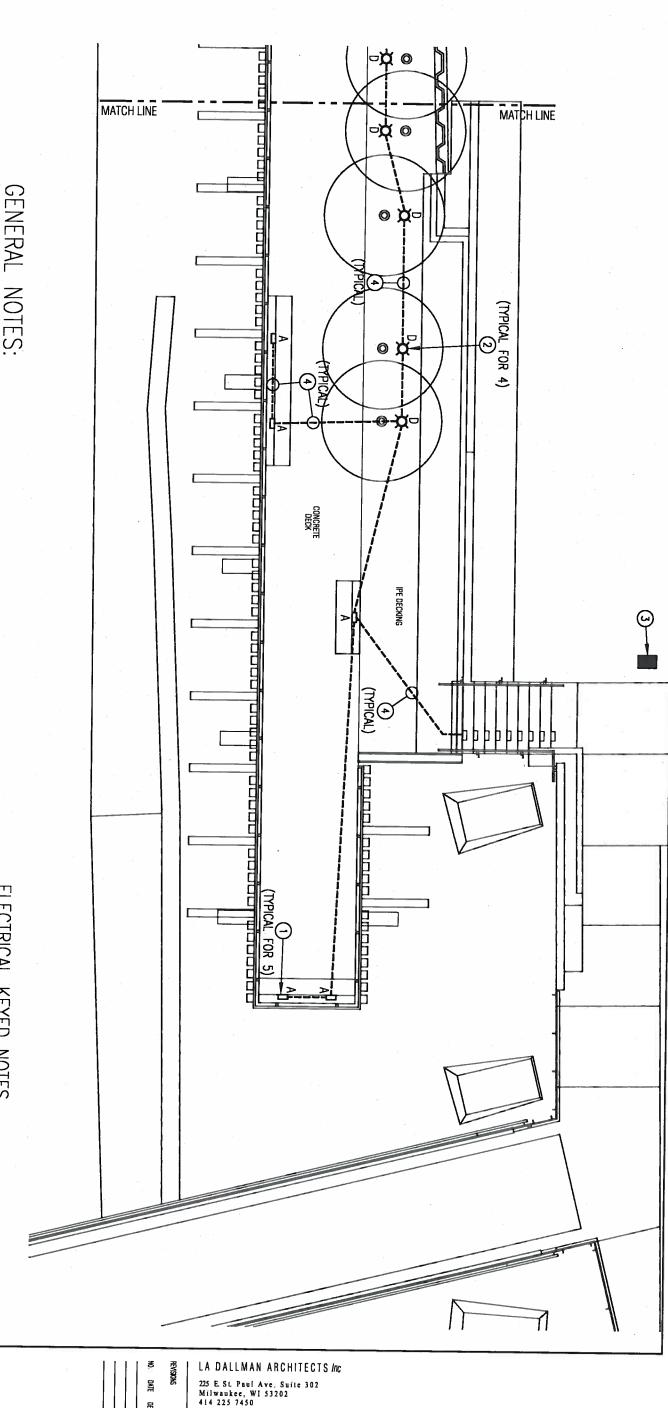
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ELECTRICAL KEYED NOTES

- TYPE "A" LUMINAIRES ARE RECESSED LED STEP LIGHTS. INSTALL THE BACK HOUSING FURNISHED WITH FIXTURE IN CONCRETE PRIOR TO POUR. CONNECT FIXTURES WITH 3/4" PVC CONDUIT. LED DRIVERS ARE INTEGRAL TO THE FIXTURE.
- TYPE "D" LUMINAIRES RECESSED IN-GRADE UPLIGHT WITH COOL TOUCH LENS. MOUNT FIXTURE HOUSING THROUGH IPE DECKING MATERIAL. SUPPORT HOUSING BELOW DECK AS REQUIRED TO MAINTAIN A RIGID INSTALLATION AND PREVENT MOVEMENT. REFER TO ARCHITECTURAL DETAILS ON SHEET A3.6
- (4) PROVIDE A 3/4" CONDUIT FROM LUMINAIRE TO LUMINAIRE AS SHOWN. CONDUIT TO BE RIGID STEEL CONDUIT WHEN EXPOSED. CONDUIT CAN BE PVC WHEN INSTALLED IN CONCRETE OR BELOW GRADE. ALL CONDUIT TO BE PAINTED TO MATCH AS REQUIRED. NEW LIGHTING PULL BOX LOCATED IN-GRADE ON EACH SIZE OF E1.1 FOR MORE INFORMATION AND CONTINUATION OF ELECTRICAL PLAZA. REI L RACEWAYS. REFER TO SHEET

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E1.2

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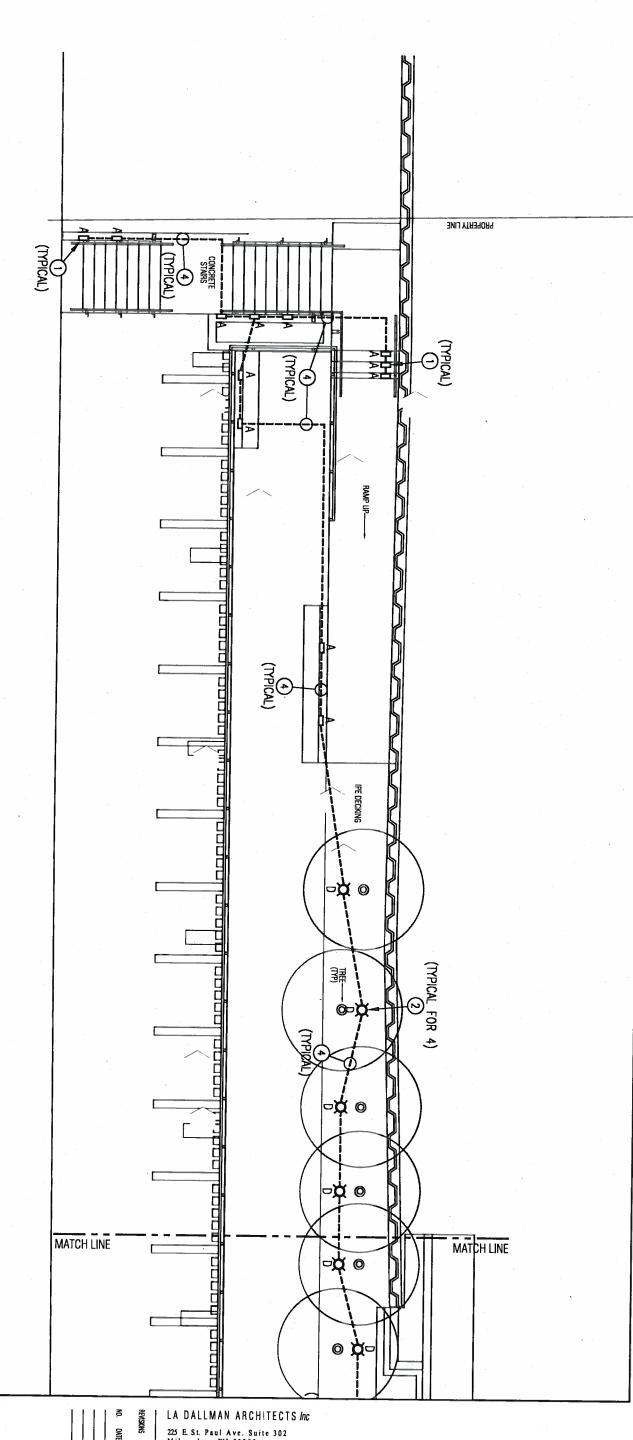
RWW RWW 0709 03.28.2011 1/8" = 1'-0"

TRESTLE EAST -ELECTRICAL PLAN CONSTRUCTION DOCUMENTS

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DESCRIPTION

225 E. St. Paul Ave. Suite 302 Milwaukee, WI 53202 414 225 7450 fax 225 7451



PROVIDE A 3/4" CONDUIT FROM LUMINAIRE TO LUMINAIRE AS SHOWN. CONDUIT TO BE RIGID STEEL CONDUIT WHEN EXPOSED. CONDUIT CAN BE PVC WHEN INSTALLED IN CONCRETE OR BELOW GRADE. ALL CONDUIT TO BE PAINTED TO MATCH AS REQUIRED.

(3) NEW LIGHTING PULL BOX LOCATED IN-GRADE ON EACH SIZE OF PLAZA. REFER TO SHEET E1.1 FOR MORE INFORMATION AND CONTINUATION OF ELECTRICAL RACEWAYS.

TYPE "D" LUMINAIRES - RECESSED IN-GRADE UPLIGHT WITH COOL TOUCH LENS, MOUNT FIXTURE HOUSING THROUGH IPE DECKING MATERIAL. SUPPORT HOUSING BELOW DECK AS REQUIRED TO MAINTAIN A RIGID INSTALLATION AND PREVENT MOVEMENT. REFER TO ARCHITECTURAL DETAILS ON SHEET A3.6

DRAWN BY CHECKED BY PROJECT NO DATE SCALE

TRESTLE WEST -ELECTRICAL PLAN

CONSTRUCTION DOCUMENTS

RWW RWW 0709 03,28,2011 1/8" = 1'-0"

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ALL LUMINAIRES (TYPE A, TYPE D) ON THIS SHEET SHALL BE WIRED TO PANEL "A", CIRCUIT 1/3 (240-VOLT) WITH (2) #12 AWG, (1) #12 AWG GROUND IN 3/4" SCHEDULE 80 PVC CONDUIT.

GENERAL NOTES:

THE LOCATION AND INSTALLATION INFORMATION FOR THE GUARDRAIL LIGHT FIXTURE (TYPE E - SPV.0090.01) IS SHOWN IS INDICATED ON SHEET E1.4

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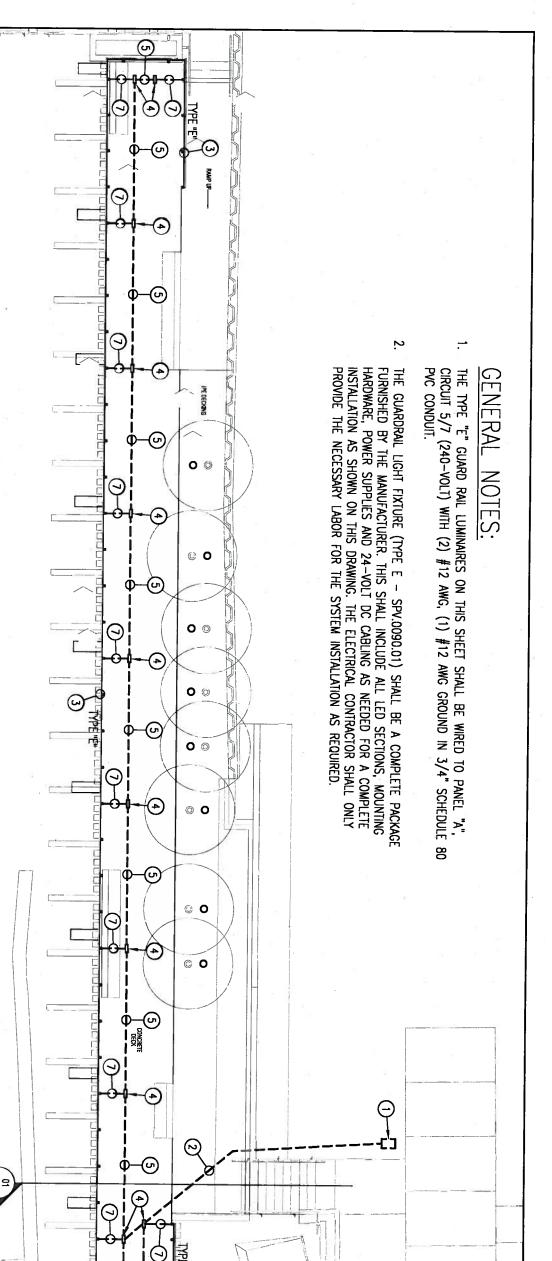
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TYPE "A" LUMINAIRES ARE RECESSED LED STEP LIGHTS. INSTALL THE BACK HOUSING FURNISHED WITH FIXTURE IN CONCRETE PRIOR TO POUR. CONNECT FIXTURES WITH 3/4" PVC CONDUIT. LED DRIVERS ARE INTEGRAL TO THE FIXTURE.

ELECTRICAL KEYED NOTES

DATE DESCRIPTION

225 E. St. Paul Ave. Suite 302 Milwaukee, WI 53202 414 225 7450 fax 225 7451



NEW LIGHTING PULL BOX LOCATED IN-GRADE ON EACH SIZE OF PLAZA. REFER TO SHEET E1.1 FOR MORE INFORMATION AND CONTINUATION OF ELECTRICAL RACEWAYS.

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KEYED NOTES

PROVIDE A 3/4" PVC CONDUIT AT +18" BELOW GRADE OR IN CONCRETE FROM PULL BOX TO FIRST LED POWER SUPPLY AS SHOWN.

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TYPE "E" LUMINAIRES — CONTINUOUS LED STRIP LIGHT. TYPE "E" FIXTURE TO BE INSTALLED IN AT ANGLE PROVIDED WITH TRESTLE LANDING DECORATIVE HANDRAIL. REFER TO THE ARCHITECTURAL SECTION ON SHEET A3.1 FOR LOCATION. PROVIDE WIRING UP FROM POWER SUPPLY AT HANDRAILS AS NEEDED. CONCEAL ALL WIRING AS MUCH AS POSSIBLE.

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POWER SUPPLY WITH LED DRIVERS FOR TYPE "E" LUMINAIRE. LOCATE DISTANCE FOR 24-VOLT CABLING TO FIXTURE. (TYPICAL FOR 13 PERPENDICULAR TO POST LOCATION AS SHOWN TO MINIMIZE CABLE HARD WIRE CONNECTION TO POWER SUPPLY AS REQUIRED. SECTION "01/E1.4" ON THIS SHEET FOR MORE INFORMATION. PROVIDE POWER SUPPLY BELOW CONCRETE DECK AND TRESTLE TIES. REFER TO MOUNT

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SCALE: 1/8" = 1'-0"

TRESTLE

(F) PROVIDE A 3/4" RIGID STEEL PROVIDE A 3/4" RIGID STEEL CONDUIT BELOW NEW CONCRETE DECKING FROM POWER SUPPLY TO POWER SUPPLY AS SHOWN. CONDUIT TO BE PAINTED TO MATCH AS REQUIRED.

LOCATION OF A STEEL POST FOR GUARDRAIL TO BE USED FOR 24-VOLT DC CABLING UP TO LED FIXTURE. REFER TO SECTION "01/E1.4" ON THIS SHEET AND ARCHITECTURAL SHEETS A2.0, A2.1, A3.1 AND A3.2 FOR MORE ARCHECTURAL SECTIONS AND DETAILS. (TYPICAL)

PROVIDE A 1/2" PVC CONDUIT FOR 24-VOLT CABLING PATHWAY. MOUNT CONDUIT WITHIN NEW CONCRETE SLAB AS SHOWN IN SECTION "01/E1.4" ON THIS SHEET. CONDUIT TO FROM POWER SUPPLY TO POST AS SHOWN

PROVIDE 24-VOLT CABLING FROM POWER SUPPLY TO TYPE "E" GUARDRAIL LIGHTING FIXTURE AS REQUIRED. CABLING TO BE WITHIN CONDUIT UP TO POST AND EXPOSED WITHIN HOLLOW RECTANGULAR POST UP TO FIXTURE AS SHOWN. (TYPICAL FOR 13 LOCATIONS)

©

STUB INTO HOLLOW RECTANGULAR POST.

TRESTLE GUARDRAIL LIGHTING PLAN CONSTRUCTION DOCUMENTS

RWW RWW 0709 03.28.2011 3/32" = 1'-0"


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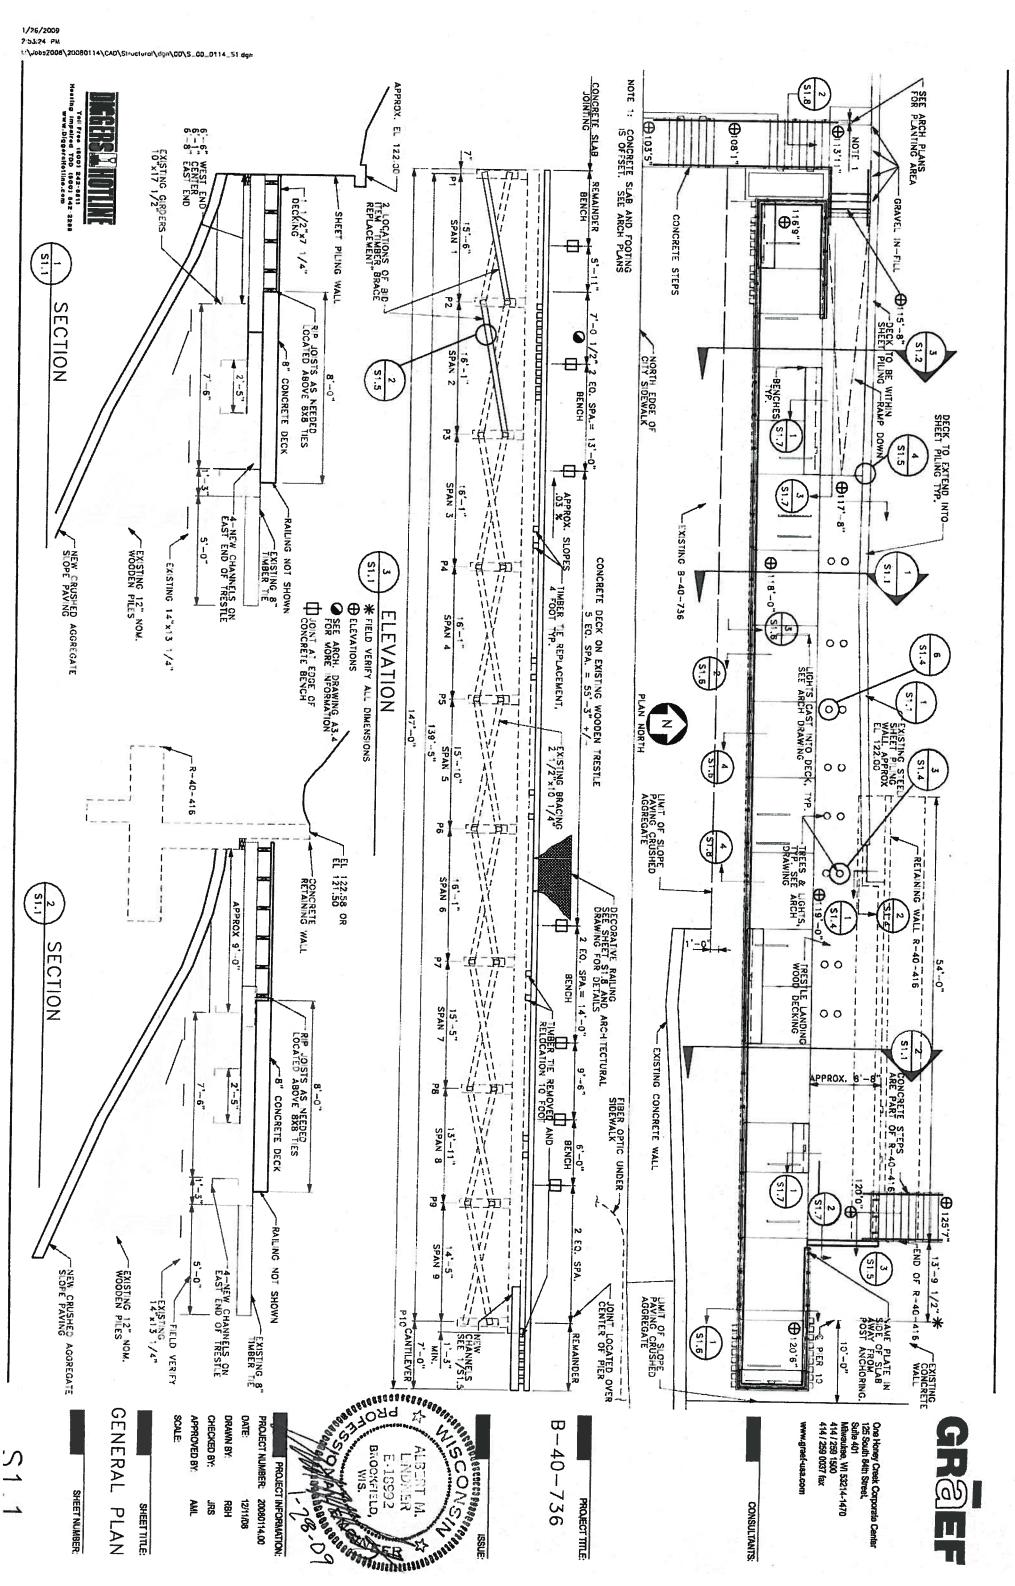
MATRIX GROUP

H

DESCRIPTION

(G)



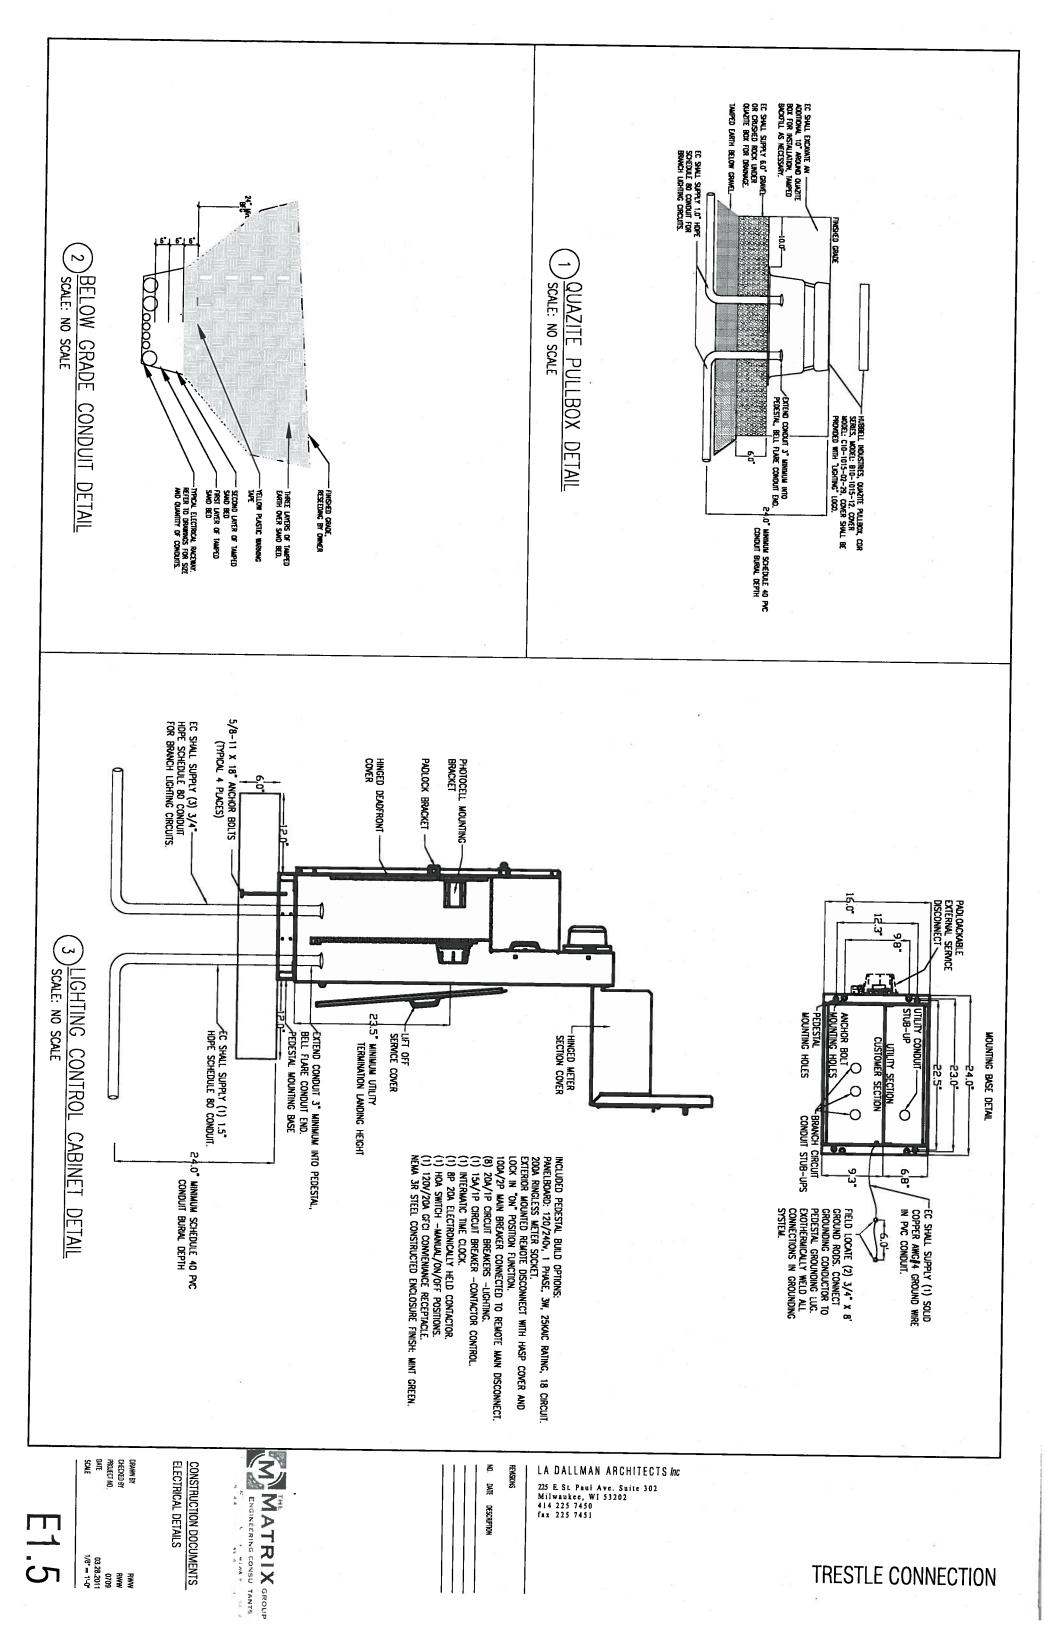

SSUE

GENERAL NOTES

DRAWINGS SHALL NOT BE SCALED.

ALL DIMENSIONS ARE IN FEET AND INCHES.

BAR STEEL REINFORCEMENT SHALL BE EMBEDDED 2" CLEAR UNLESS SHOWN OR NOTED OTHERWISE.

THE EXISTING GROUND LINE SHALL BE THE UPPER LIMITS OF EXCAVATION FOR STRUCTURES.

THE SLOPE OF THE FILL IN FRONT OF THE EXISTING STEEL SHEET PILE AND NEW CONCRETE RETAINING WALL SHALL BE COVERED WITH SLOPE PAVING CRUSHED AGGREGATE TO THE EXTENT SHOWN ON THE PLAN.

THE FIRST DIGIT OF A THREE DIGIT AND THE FIRST TWO DIGITS OF A FOUR DIGIT BAR MARK SIGNIFIES THE BAR SIZE.

CONTRACTOR SHALL SUPPLY A NAME PLATE IN ACCORDANCE WITH SECTION 520.3.11 OF THE STANDARD SPECIFICATIONS AND THE STANDARD DETAILED DRAWING S.D.D.12A3—B. THE NEW NAME PLATE SHALL SHOW THE CONCRETE DECK CONSTRUCTION YEAR. THE LOADING SHOWN ON THE PLATE SHALL BE "100 PSF", INCLUDE COST OF NAME PLATE AS INCIDENTAL TO BID ITEM "CONCRETE MASONRY BRIDGES".

SEE ARCHITECTURAL/ELECTRICAL DRAWINGS FOR LIGHTING DETAILS.

THE CONCRETE DECK SHOULD FOLLOW THE ELEVATION OF THE TOP OF THE TIMBER TIES AND NOT NECESSARILY THE PROFILE. THE THICKNESS OF THE CONCRETE DECK MAY VARY BY 1/4 INCH IN ORDER TO PROVIDE A SMOOTHER TOP OF DECK ELEVATION.

DESIGN DATA

DESIGN100 PSF

STRUCTURAL CARBON STEEL.....fy = 36 KSI MIN.

DESIG	N DATA FOR	DESIGN DATA FOR TYPE S EPOXY ANCHORS	ANCHORS
ANCHOR SIZE	MIN. EMBED	SHEAR (KIPS)	PULLOUT (KIPS)
3/8"	5"	4.0	9.7
1/2"	5"	7.8	12.0
5/8"	6,1	11.2	17.2

BM#2	BM#1	NUMBER	
CHISLED + IN SOUTH END OF 12" WALL BETWEEN BITUMINOUS PATH AND THE BEGINNING OF THE CURVE IN THE PATH.	NW. BOLT TOP FLANGE OF FIRE HYDRANT ON WEST SIDE OF COMMERSE ST. ACROSS FROM LAKEFRONT BREWERY, INC.	LOCATION	BENCHMARKS
125.96	105.23	ELEVATION	:

SLOPE 0.03 FT/FT

PROFILE OF DECK

P

P10

		_	ß	TRESTLE AND NORTH LANDING WOOD DECKING 8-40-736	SPV.0105.04
		-	LS	WEST STAIRS DECORATIVE RAILING	SPV.0105.03
		, -	S	TRESTLE LANDING DECORATIVE RAILING 8-40-736	SPV.0105.01
		2	EACH	TIMBER BRACE REPLACEMENT	SPV.0060.03
		40	EACH	TIMBER TIE REPLACEMENT 4 FOOT	SPV.0060.02
		20	EACH	TIMBER TIE REMOVAL AND RELOCATION 10 FOOT	SPV.0060.01
AGGREGATE ON SLOPE	INCLUDES REPAIR OF EXISTING AGGREGATE ON SLOPE	400	SY	SLOPE PAVING CRUSHED AGGREGATE	604.0500
	WEST STAIRS ONLY	230	Ş	CONCRETE STEPS	602.1500
	154	2.1	MBM	TREATED LUMBER AND TIMBER	507.0200
		3200	Б	STRUCTURAL STEEL HS	506.0605
	NEW CHANNELS AT EAST END	2620	Ш	STRUCTURAL STEEL CARBON	506.0105
	INCLUDES TRESTLE BENCHES	4590	6	BAR STEEL REINFORCEMENT HS COATED BRIDGES	505.0605
S1.9 WEST STAIRS	INCLUDES TRESTLE BENCHES	32	ণ	CONCRETE MASONRY BRIDGES	502.0100
S1.5 CONCRETE DECK D			rs	EXCAVATION FOR STRUCTURES BRIDGES B-40-736	206.1000
S1.5 DETAILS		_	۲	REMOVING OLD STRUCTURE B-40-736	203.0200
S1.3 DEMOLITION PLAN		QUANTITY	TINU	ITEM DESCRIPTION	ITEM NUMBER
S1.1 GENERAL PLAN				ESTIMATED QUANTITIES	,
	Г				

ABOVE QUANTITIES ARE ESTIMATED, PAYMENT IS BASED ON "AS-BUILT" QUANTITIES.
SEE ARCHITECTURAL DRAWINGS FOR THE ELECTRICAL WORK ON THE STRUCTURE.

B-4	
0 - 73	_
36	ROJECT TITL

NEW 4 BY CUT
TD CORRECT HEIGHT
ABOVE NEW 8x8

9 2'-0" O.C. NEW 8x8 2 -0 0.C. APPROX. 6'-6"WEST END EXISTING GIRDERS SHIM ABOVE NEW BXB — BEAMS OR THICKEN CONCRETE DECK (+1/2") 1 1/2"x7 1/4" DECKING. STAGGER END JOINTS. SHEET PILING SAW CUT EXISTING TIE AT LOCATION OF NEW B x B TIE 2'-6" 8,-0, CRUSHED AGGREGATE SLOPE PAVING B" CONCRETE DECK -EXISTING 12" NOM. WOODEN PILES EXISTING 14"x13 1/4" EXISTING Bx8 2'-0" O.C. RAILING NOT SHOWN -EXISTING 8"
TIMBER TIE

SECTION

CITY OF MILWAUKEE CONTACT: CRAIG LIBERTO 414-286-3294 CONSULTANT CONTACT:
ALBERT M. LINDNER 414-259-1500

> DATE: PROJECT NUMBER: 20080114.00 PROJECT INFORMATION: 12/11/08

GENERAL NOTES SHEET TITLE:

SCALE

CHECKED BY:

DRAWN BY:

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APPROVED BY:

SHEET NUMBER:

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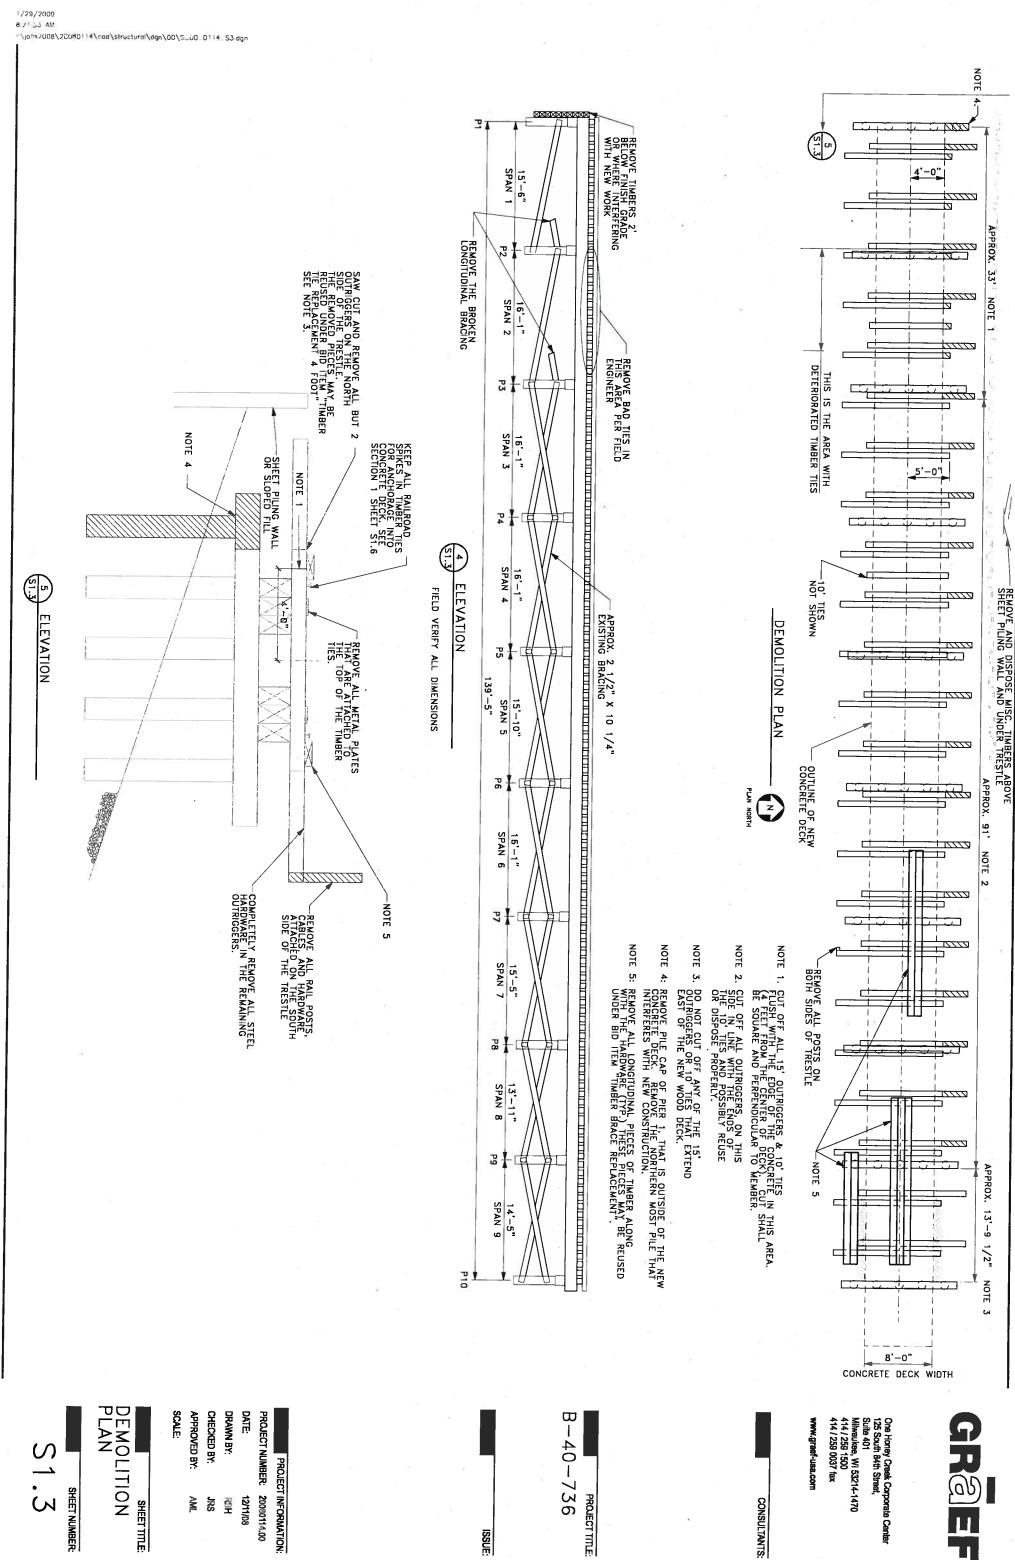
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DRAWINGS


S1.1 GENERAL PLAN
S1.2 QUANTITIES & GENERAL NOTES
S1.3 DEMOLITION PLAN
S1.4 FRAMING DETAILS
S1.5 DETAILS
S1.5 CONCRETE DECK DETAILS
S1.7 DECK DETAILS
S1.8 DECORATIVE RAILING DETAILS
S1.9 WEST STAIRS

Milwaukee, WI 53214-1470 414 / 259 1500 414 / 259 0037 fax One Honey Creek Corporate Center 125 South 84th Street, Suite 401 www.graef-usa.com CONSULTANTS:

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ISSUE:



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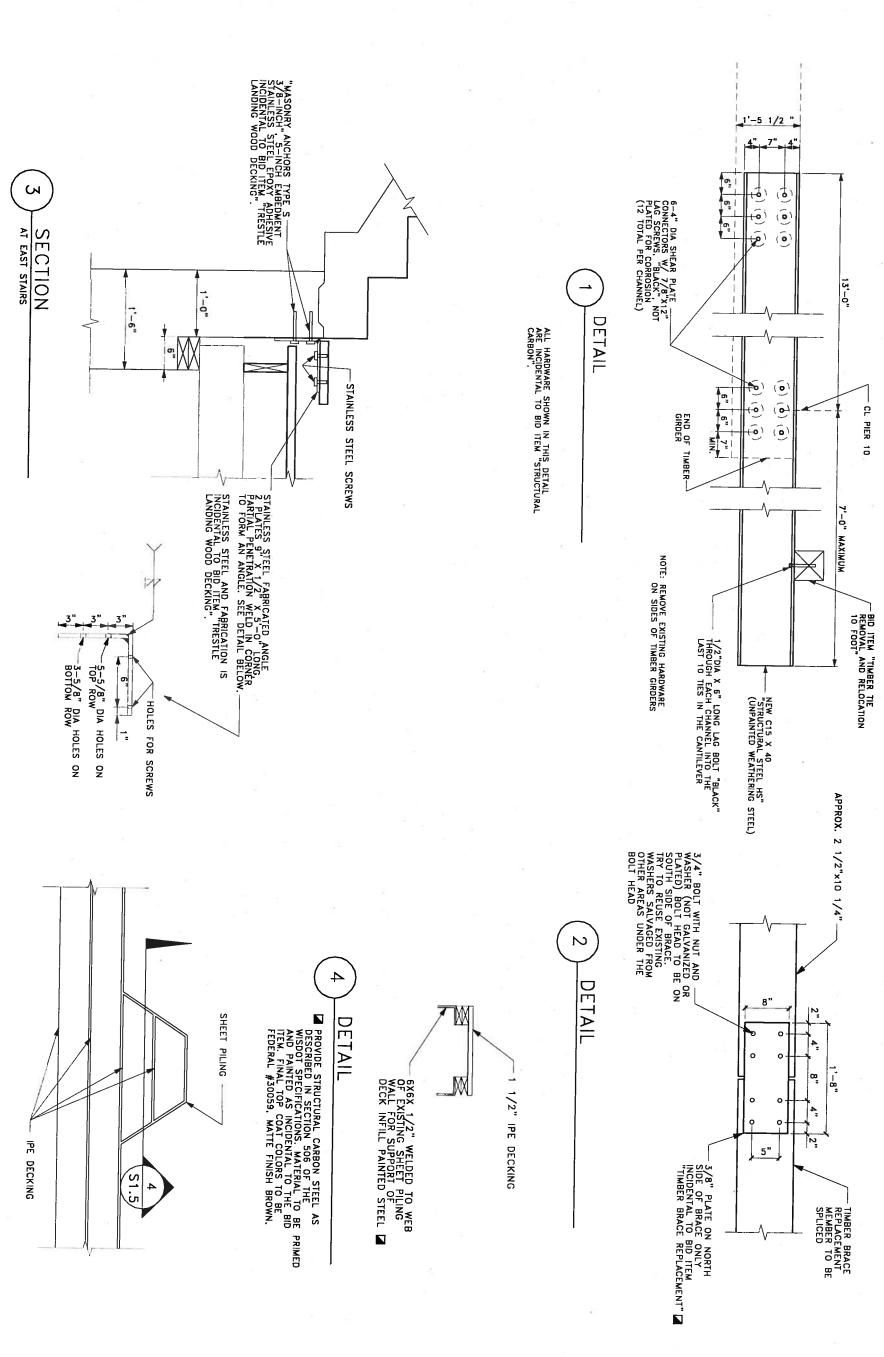
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PROJECT INFORMATION:

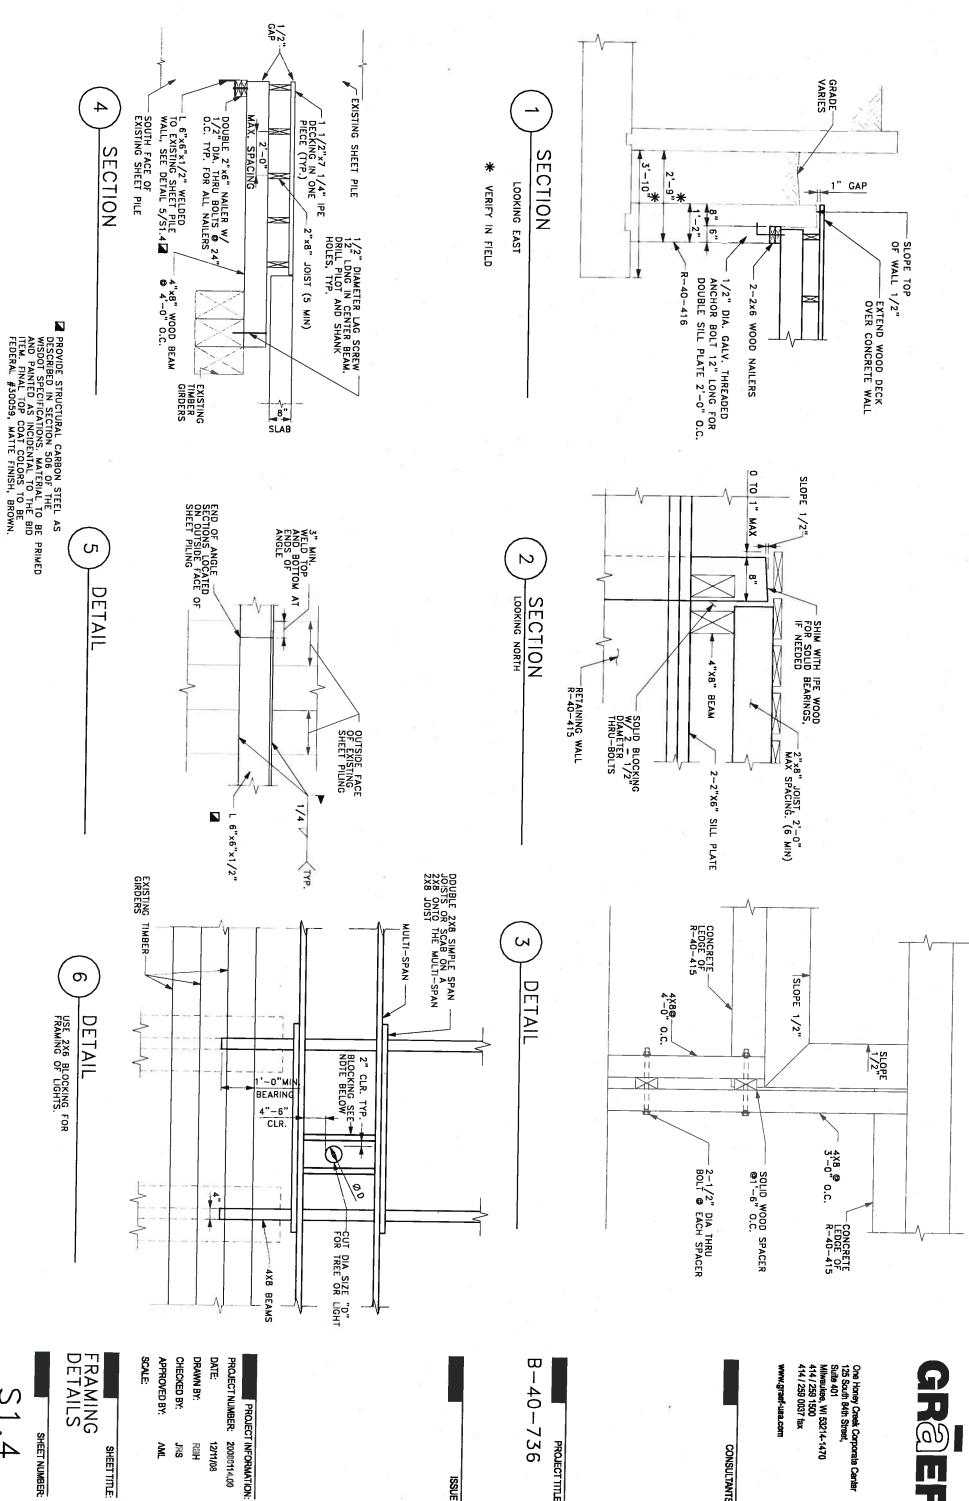RB 12/11/08

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40-736

ISSUE:

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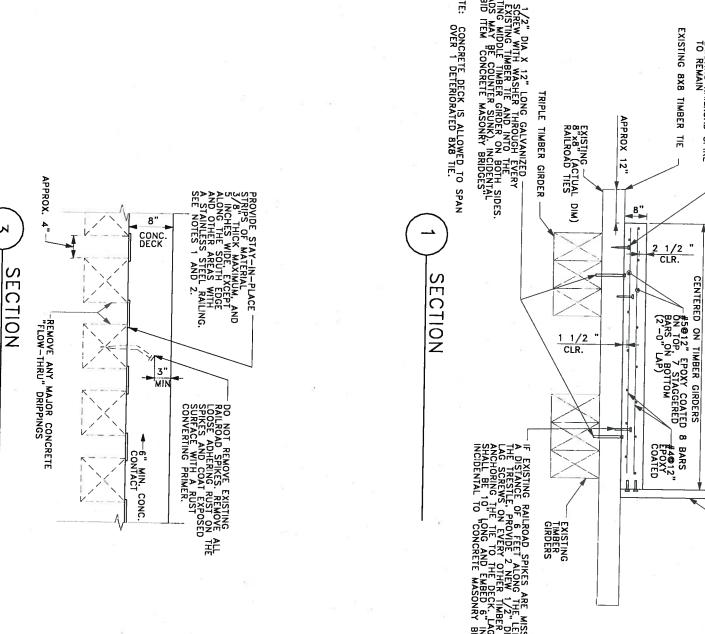
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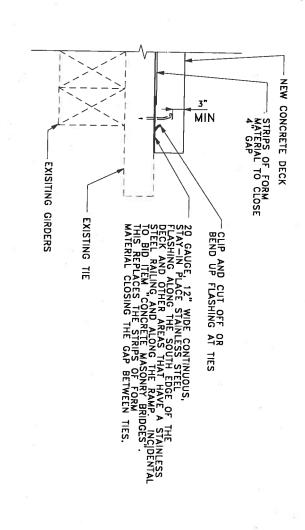
NOTE 1. STAY-IN-PLACE FORMS MAY BE WIDER THAN 5", (AS ALLOWED WHEN GOOD TIES ARE ON EACH SIDE OF A DETERIORATED TIE).

NOTE 2. DESIGN FORM MATERIAL FOR ALL CONSTRUCTION LOADS AND CONDITIONS. APPEARANCE OF MATERIAL SHALL BE APPROVED BY THE FIELD ENGINEER.

SECTION

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SECTION

B-40-736


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PROJECT TITLE:

EXISTING 8X8 TIMBER TIE

EXISTING RAILROAD SPIKE TO REMAIN

8'-0"

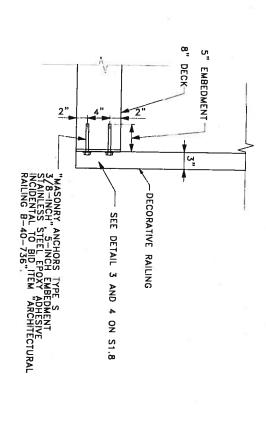

CONCRETE
DECK
DETAILS SCALE: CHECKED BY: DATE DRAWN BY: PROJECT NUMBER: 20080114.00 APPROVED BY: R 12/11/08 S

PROJECT INFORMATION:

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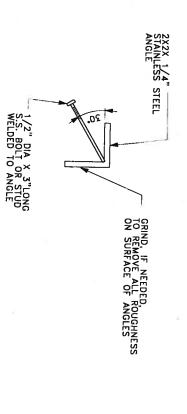
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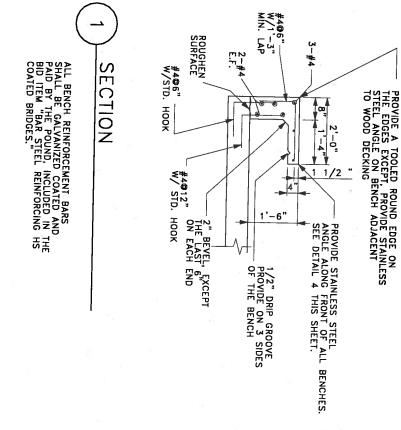
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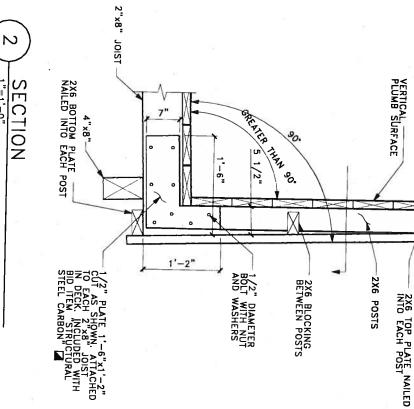
CONSULTANTS:

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DETAIL








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1"=1'-0"



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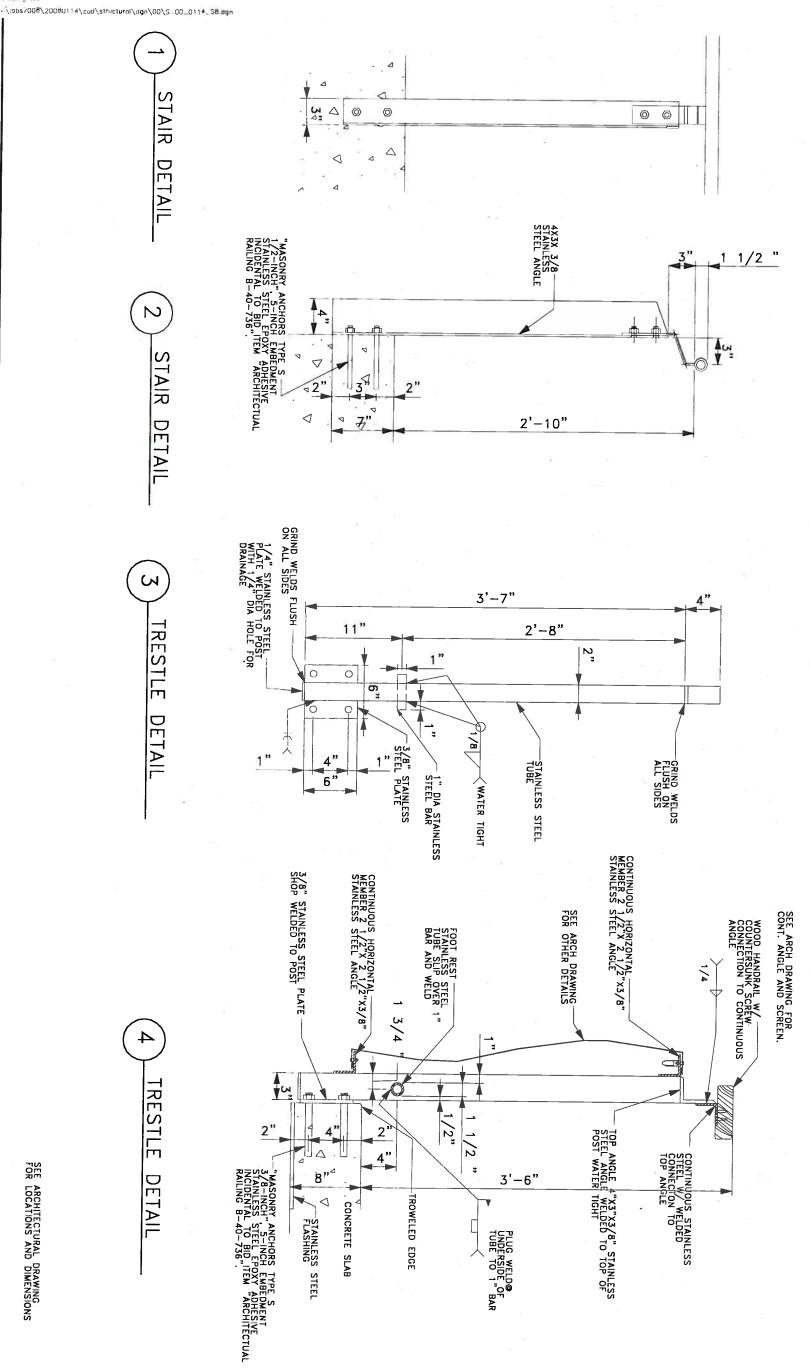
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DECK DETAILS SHEET TITLE:

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SEE ARCHITECTURAL DRAWING FOR LOCATIONS AND DIMENSIONS

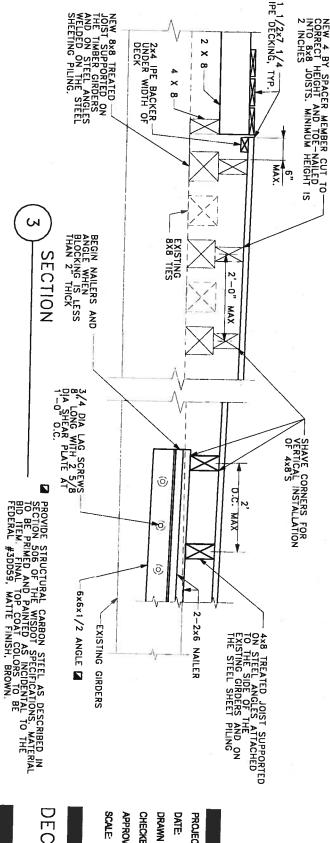S1.8

SHEET NUMBER:

DECORATIVE RAILING DETAILS

SHEET TITLE:

SCALE

CHECKED BY: DRAWN BY:


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DATE:


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CONSULTANTS:

PS

PROJECT TITLE:

R-40-416

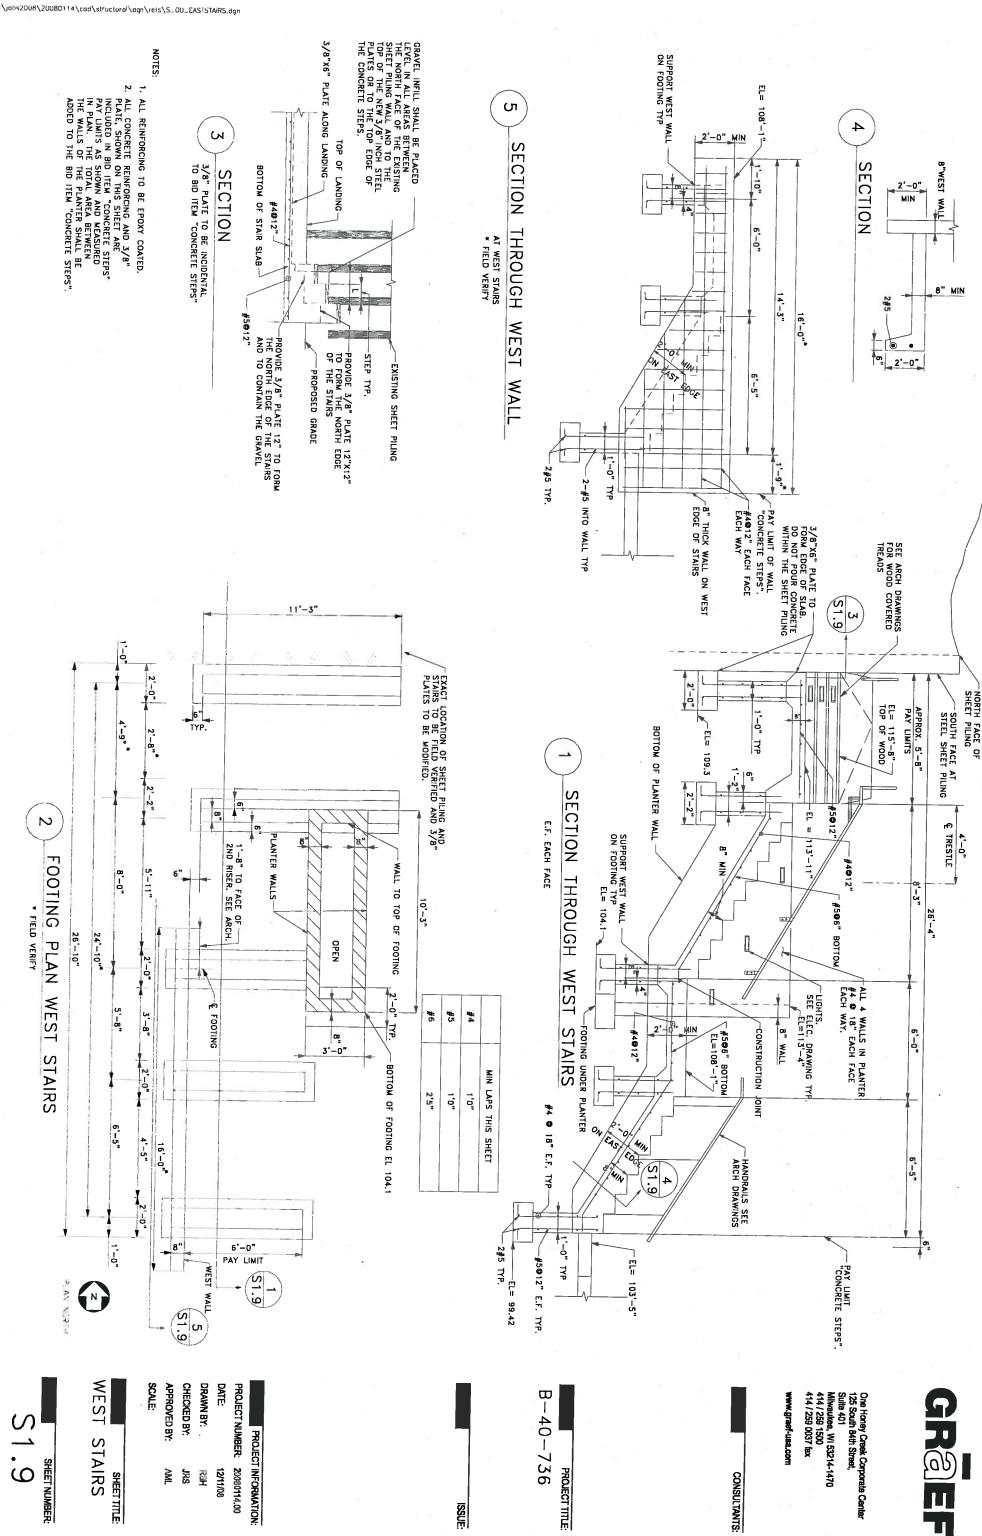ALBERT M. L.ND.YER E-18992
BROOKFIELD, WIS. 9 bo wi

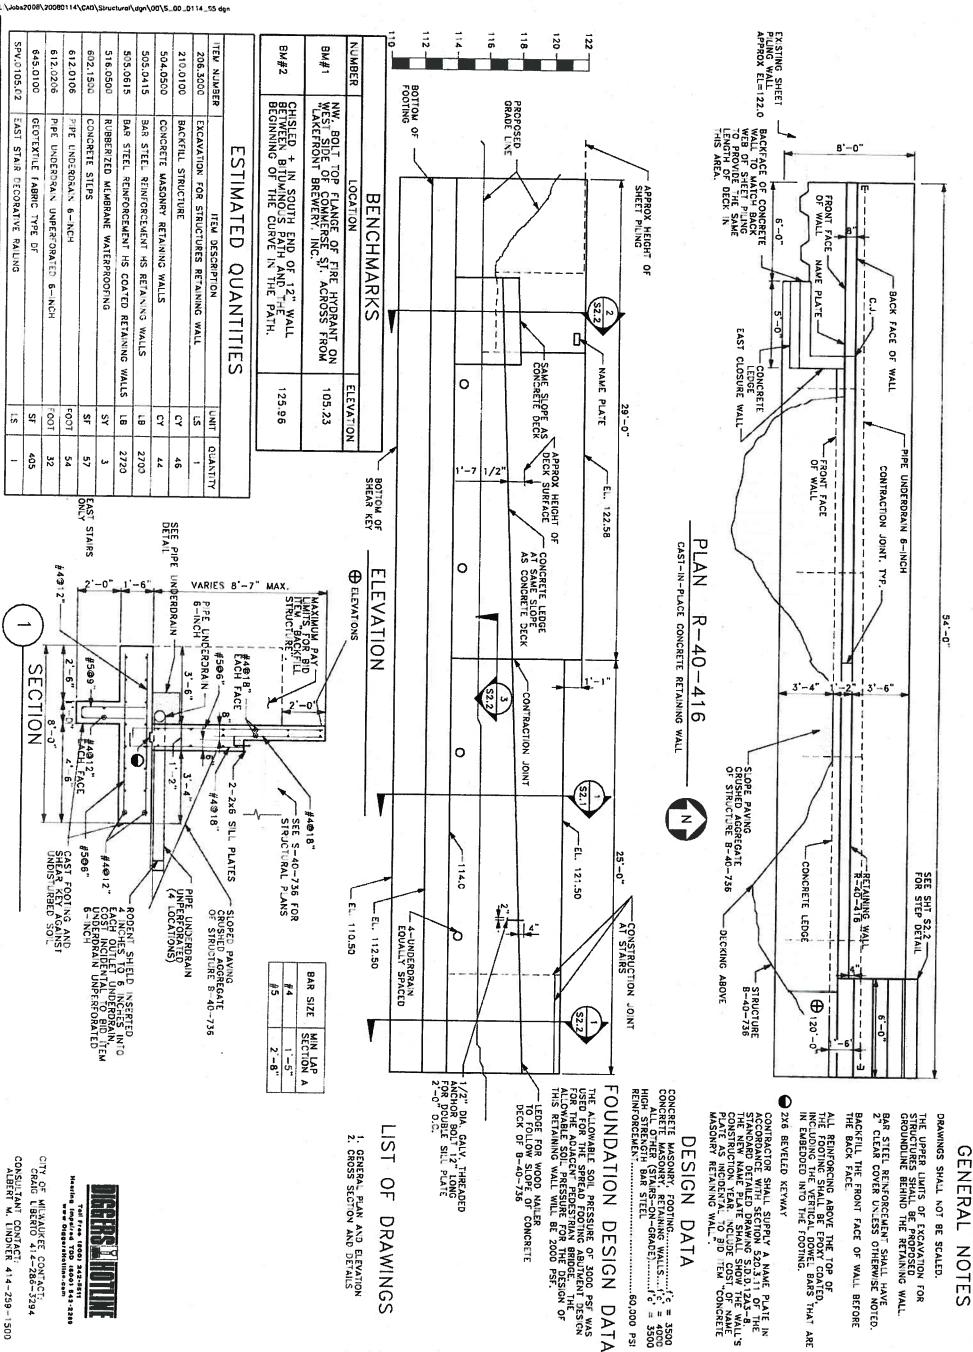
DATE DRAWN BY: PROJECT NUMBER: 20080114.00 PROJECT INFORMATION: 異 12/11/08

GENERAL PLAN AND ELEVATION SHEET TITLE:

APPROVED BY CHECKED BY:

Z

SHEET NUMBER:

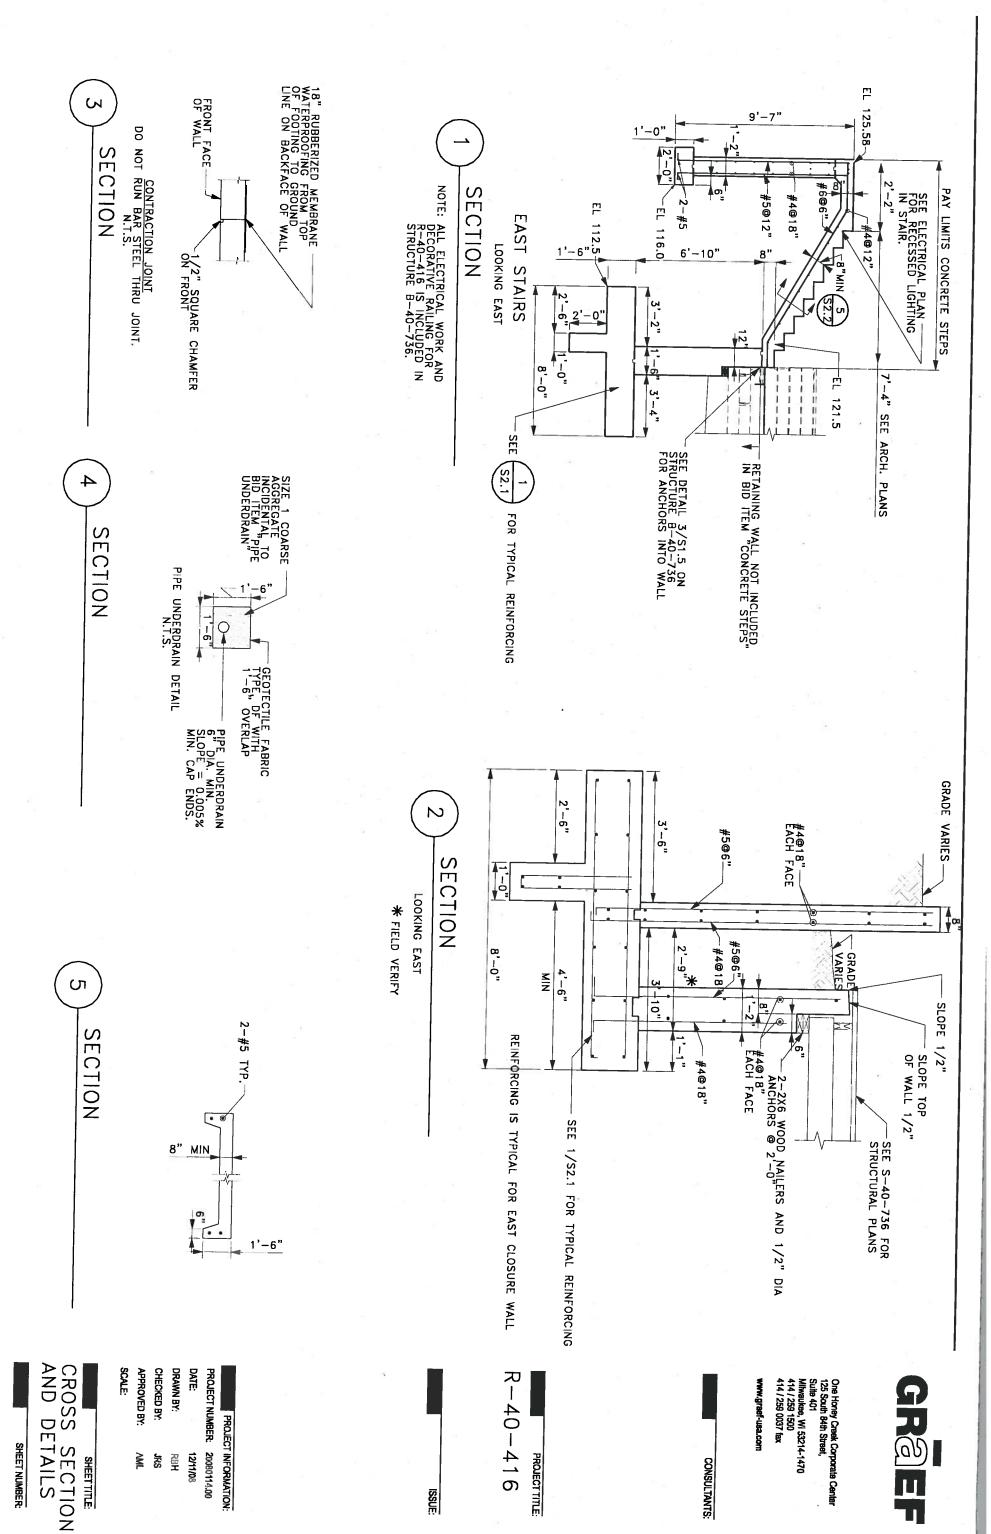

ISSUE

CONSULTANTS:

SECTION THROUGH BENCH

SECTION

THROUGH BENCH

JORACE #4 @ 12" EACH WAY #3@8" EACH WAY POR DEFIT OF EMBEDMENT

SECTION THROUGH BENCH

FOR ALE LIGHTING SECTION THROUGH BENCH 5 1/4 ES & S" EACH WAY

SHEETTITLE

SCALE

STE HEMS ON THIS SHEET TO BE BENCHES

SHEET TO BE GALVANIZED COATED.

PLAZA BENCH

SHEET NUMBER


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414 / 259 1500
414 / 259 0037 fax


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CONSULTANTS

PROJECT TITLE

MARSUPIAL TRESTLE STAIR



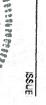

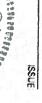

1600

ALBERT W. SCONS

PROJECT INFORMATION: 12/11/08

DATE DRAWN BY PROJECT NUMBER: 20080114.00

CHECKED BY: APPROVED BY AMIL AMIL